


STATE HIGHWAY ADMINISTRATION

S.H.A. CONTRACT NO. – PGA115133 FEDERAL AID PROJECT NO. - AC-STBG-1194(5)E

MD 725 (MAIN STREET) FROM WEST OF SERVICE LANE TO EAST OF GOVERNOR ODEN BOWIE DRIVE SIDEWALKS

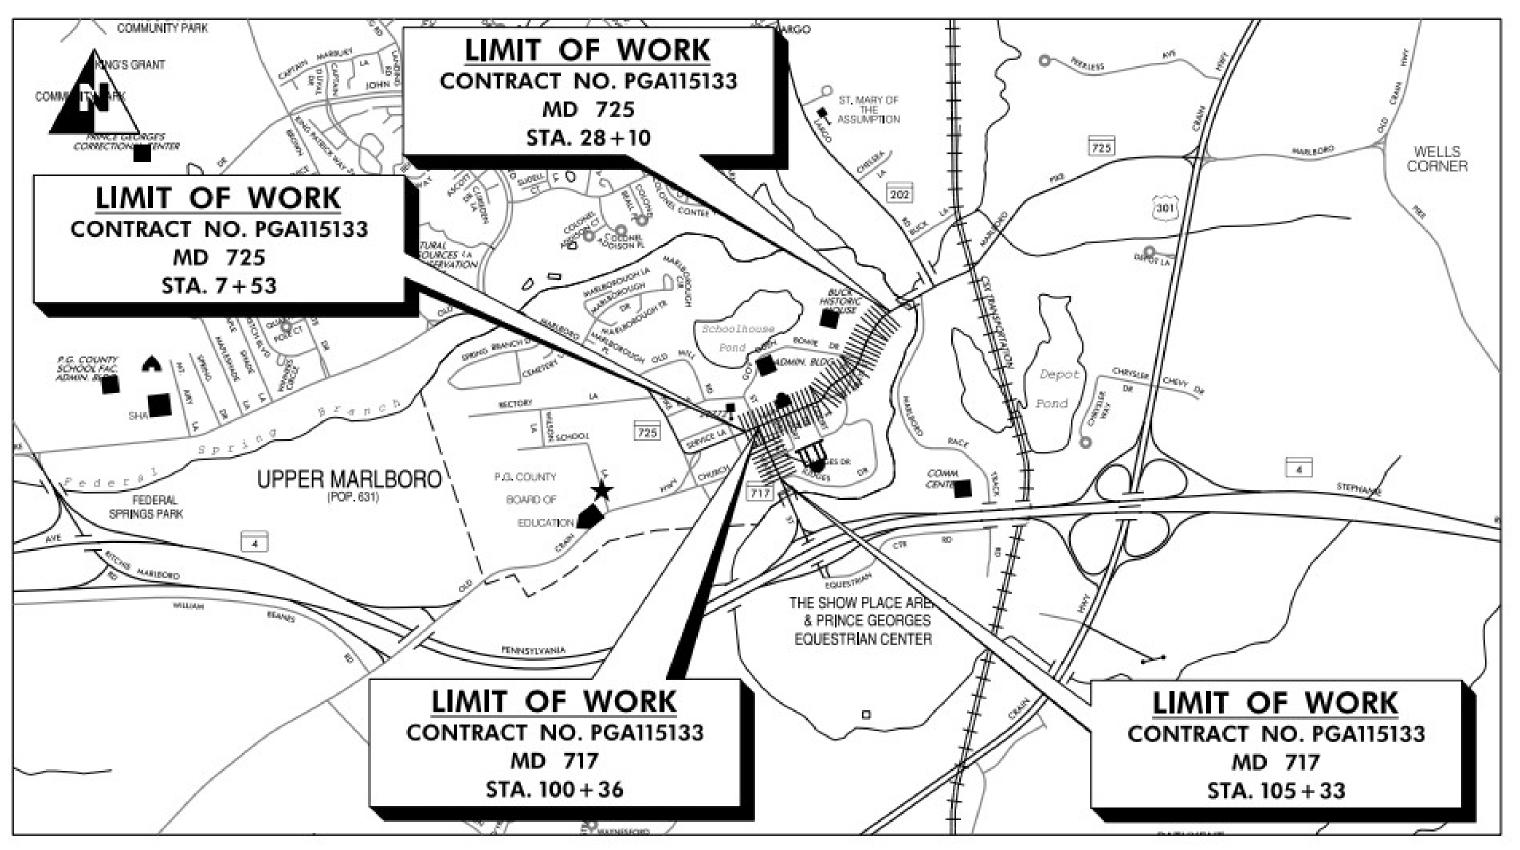

UPPER MARLBORO PRINCE GEORGE'S COUNTY

LENGTH OF PROJECT: MD RTE. 725 = 0.39 MILES MD RTE. 717 = 0.10 MILES SCALE: 1" = 1000"

REVISIONS

REVISED SHEET NUMBERS

STORMWATER AND SEDIMENT CONTROL APPROVAL

DIVISION CHIEF, PLAN REVIEW DIVISION

GEOMETRIC DESIGN CRITERIA

RIGHT OF WAY PLATS.

UTILITIES

REQUIREMENTS.

ENVIRONMENTAL INFORMATION

STANDARD STABILIZATION NOTE:

OR GRADED AREAS ON THE PROJECT SITE.

EXISTING STRUCTURES PLANS

OWNERS / DEVELOPERS CERTIFICATION:

THIS PROJECT WAS DESIGNED IN ACCORDANCE WITH THE 2018 PUBLICATION OF

STANDARD SPECIFICATIONS BOOK, BOOK OF STANDARDS AND MARYLAND

ALL WORK ON THIS PROJECT SHALL CONFORM TO THE LATEST APPROVED MARYLAND

AMERICAN ASSOCIATION OF STATE HIGHWAY AND TRANSPORTATION OFFICIALS (AASHTO) "A POLICY ON GEOMETRIC DESIGN OF HIGHWAYS AND STREETS."

MANUAL ON UNIFORM TRAFFIC CONTROL DEVICES (MDMUTCD)

DEPARTMENT OF TRANSPORTATION STATE HIGHWAY ADMINISTRATION (MDOT SHA) "STANDARD SPECIFICATIONS FOR CONSTRUCTION AND MATERIALS" REVISIONS

BIDS BOOK, THE ADMINISTRATION'S "BOOK OF STANDARDS FOR HIGHWAYS AND

THE LOCATION OF UTILITIES SHOWN ON THE PLANS ARE FOR INFORMATION AND

THE DESIGN OF THIS PROJECT HAS INCORPORATED FACILITIES TO ACCOMMODATE

ALL STORMWATER MANAGEMENT FACILITIES CONSTRUCTED FOR THIS CONTRACT.

SHALL BE INSPECTED AND MAINTAINED IN ACCORDANCE WITH THE MOOT SHA BEST

INCIDENTAL STRUCTURES" AND THE LATEST VERSION OF MDMUTCD.

RIGHT OF WAY AND EASEMENT LINES SHOWN ON THESE PLANS ARE FOR ASSISTANCE IN INTERPRETING THE PLANS. THEY ARE NOT OFFICIAL FOR OFFICIAL FEE RIGHT OF WAY AND EASEMENT INFORMATION, SEE APPROPRIATE

GUIDANCE ONLY. NO GUARANTEE IS MADE OF THE ACCURACY OF SAID

PERSONS WITH DISABILITIES IN COMPLIANCE WITH STATE AND FEDERAL

MANAGEMENT PRACTICES (BMP) INSPECTION AND REMEDIATION PROGRAM

FOLLOWING INITIAL SOIL DISTURBANCE OR REDISTURBANCE, PERMANENT OR

DAYS AS TO THE SURFACE OF ALL PERIMETER CONTROLS, DIKES, SWALES, DITCHES, PERIMETER SLOPES, AND ALL SLOPES GREATER THAN 3 HORIZONTAL

TO 1 VERTICAL (3.1), AND SEVEN DAYS (7) AS TO ALL OTHER DISTURBED

DEVELOPMENT WILL BE DONE PURSUANT TO THIS PLAN, AND THAT ANY

A CERTIFICATE OF ATTENDANCE AT A MARYLAND DEPARTMENT OF THE

AND EROSION BEFORE BEGINNING THE PROJECT. I HEREBY AUTHORIZE THE

FOR THE CONVENIENCE AND INFORMATION OF BIDDERS, PRINTS OF PLANS OF EXISTING PERTINENT STRUCTURE(S) ARE INCLUDED WITH THIS CONTRACT. NO RESPONSIBILITY FOR THEIR ACCURACY OR COMPLETENESS IS ASSUMED BY THE MDOT SHA DIMENSIONS, DETAILS, ETC., AS SHOWN THEREON MAY NOT BE AS BUILT.

TEMPORARY STABILIZATION SHALL BE COMPLETED WITHIN THREE (3) CALENDAR

I/WE HEREBY CERTIFY THAT ANY CLEARING, GRADING, CONSTRUCTION AND/OR

RESPONSIBLE PERSONNEL INVOLVED IN THE CONSTRUCTION PROJECT WILL HAVE

ENVIRONMENT (MDE) APPROVED TRAINING PROGRAM FOR THE CONTROL OF SEDIMENT

RIGHT OF ENTRY FOR PERIODIC ON-SITE EVALUATION BY MDE COMPLIANCE INSPECTORS

PRD NO: 20-PR-0006-03 EXPIRATION DATE: 03/02/2025

03/01/2022

DIVISION CHIEF, INNOVATIVE CONTRACTING DIVISION

03/01/2022 DATE DIRECTOR, OFFICE OF HIGHWAY DEVELOPMENT

03/01/2022

ACTING DEPUTY ADMINISTRATOR / CHIEF ENGINEER FOR PLANNING, ENGINEERING, REAL ESTATE AND ENVIRONMENT

DATE

MD LICENSE NO. 23143 EXPIRATION DATE: 6/25/2023 N:31933-017\CADD\Task 1_WRA_PG_MD 725 from Brown Station Road to MD 202\pGN-T000_MD725.dgn

6031 UNIVERSITY BLVD, SUITE 290

ELLICOTT CITY, MARYLAND

Whitman, Requardt & Associates, LLP

Engineers · Architects · Environmental Planners Est. 1915

__ EXPIRATION DATE: ______ 7/25/2022

RIM ENGINEERING TEL:410.730.1001 FAX:410.730.5403

I HEREBY CERTIFY THAT THESE DOCUMENTS WERE PREPARED OR APPROVED BY ME, AND THAT I AM A DULY LICENSED PROFESSIONAL ENGINEER UNDER THE

HEREBY CERTIFY THAT THESE DOCUMENTS WERE PREPARED OR APPROVED BY

ME, AND THAT I AM A DULY LICENSED PROFESSIONAL ENGINEER UNDER THE

SHEET NOS. AND OTHER CLARIFICATIONS: 14

SHEET NOS. AND OTHER CLARIFICATIONS: 1-13, 15-29

LAWS OF THE STATE OF MARYLAND.

LAWS OF THE STATE OF MARYLAND.

February 28, 2022

MD LICENSE NO. 22051

STRUCTURE INVENTORY NO.:

CONTRACT NO. PGA115133

Mod 1 (PreAd) 03/31/2022

GENERAL NOTES

- 1. BASELINE SHOWN FOR ILLUSTRATIVE PURPOSES.
- 2. DIMENSIONS AND STATIONS ARE APPROXIMATE.
- 3. ALL SIDEWALK AND RAMPS SHALL BE A MINIMUM OF 60" WIDE, TAPER SIDEWALK TO EXISTING IN ACCORDANCE TO STD. NO 655.02 UNLESS NOTED OTHERWISE. SIDEWALK CROSS SLOPE SHALL BE 2% MAXIMUM WHERE THE SIDEWALK TRANSITIONS TO EXISTING, THE CROSS SLOPE SHALL TRANSITION TO
- 4. ALL TRANSITION PANELS SHALL BE TO THE NEAREST SIDEWALK JOINT (5' MIN.).
- 5. THE CONTRACTOR MAY ADJUST THE CROSS SLOPE OF THE SIDEWALK TO MAINTAIN THE POSITIVE SHEET FLOW USING A 2% MAXIMUM SIDEWALK SLOPE.
- 6. MATCH EXISTING ELEVATIONS AT THE EDGE OF PROPOSED SIDEWALK, SIDEWALK RAMPS AND CURB AND GUTTER. MAXIMUM VERTICAL ELEVATION BETWEEN ADJACENT SURFACES NOT TO
- 7. SIDEWALK RECONSTRUCTION LIMITS SHALL COINCIDE WITH CRACK CONTROL JOINTS (JOINT GROOVES) OR EXPANSION JOINTS IN EXISTING SIDEWALK. NEW EXPANSION JOINTS SHALL BE PROVIDED AT THE INTERFACE OF EXISTING AND PROPOSED SIDEWALK. SEE MDOT SHA STANDARD MD-655.01.
- 8. FORM NEW SIDEWALK AND EXPANSION JOINT MATERIAL AROUND EXISTING UTILITY POLES MANHOLE COVERS, VALVE COVERS AND FIRE HYDRANTS AS NECESSARY.
- 9. INSTALL DETECTABLE WARNING SURFACE ON SIDEWALK RAMPS AS PER MDOT SHA STANDARD MD-655.40.
- 10. ALL DRIVEWAY ENTRANCES THAT HAVE CURB RETURNS MUST CARRY A MINIMUM 36" WIDE PEDESTRIAN PATHWAY WITH A MAXIMUM 2% CROSS-SLOPE ACROSS THE ENTIRE ENTRANCE REGARDLESS OF WHAT MATERIAL IS USED TO CONSTRUCT THE ENTRANCE.
- 11. ALL DISTURBED AREAS WITHIN THE LOD SHALL RECEIVE 4"TOPSOIL AND STABLIZIED WITH TURFGRASS SOD ESTABLISHMENT UNLESS OTHERWISE NOTED.
- 12. RESET EXISTING SIGNS AND/OR RELOCATE SIGNS ON NEW POSTS AS SHOWN ON THE PLANS TO BE DISTURBED BY THE CONSTRUCTION AND AS DIRECTED BY THE ENGINEER.
- 13. ADJUST EXISTING UTILITIES AS REQUIRED.
- 14. THE CONTRACTOR SHALL REPLACE EXISTING DAMAGED CURB WHICH IS ADJACENT TO LOCATIONS WHERE CURB RAMPS ARE BEING RECONSTRUCTED OR INSTALLED.
- 15. EXISTING CURB HEIGHTS PROVIDED ON THE PLANS SHALL BE VERIFIED BY THE CONTRACTOR. RAMPS AND DRIVEWAY TRANSITION LENGTHS SHALL BE VERIFIED IN THE FIELD ACCORDING TO MDOT SHA STANDARDS MD-630.01, MD-630.02, MD-655.11, MD-655.12 AND MD 655.13.
- 16. ALL CURB REPLACEMENTS TERMINI ADJACENT TO PARKING LOT DRIVEWAY ENTRANCES SHALL BE CONSTRUCTED NOSE DOWN TO MATCH EXISTING GRADE OR AS DIRECTED BY THE ENGINEER.
- 17. EXISTING INLETS SHALL NOT BE DAMAGED DURING CONSTRUCTION. CONTRACTOR SHALL REPLACE INLETS DAMAGED BY THEIR ACTIVITIES AT NO ADDITIONAL COST TO THE ADMINISTRATION.
- 18. EXISTING TREES, SHRUBS AND THEIR RESPECTIVE ROOT SYSTEMS SHALL NOT BE DISTURBED DURING CONSTRUCTION UNLESS OTHERWISE NOTED.
- 19. PAVEMENT MARKINGS SHOWN ARE EXISTING UNITESS OTHERWISE NOTED TO BE REPLACED.
- 20. NO DISTURBED AREA SHALL BE LEFT UNSTABLIZED OVERNIGHT.
- 21. SEDIMENT AND EROSION CONTROL REGULATIONS WILL BE STRICTLY ENFORCED DURING CONSTRUCTION.
- 22. ALL NEW AND UPGRADED EXISTING CROSSWALKS SHALL FOLLOW MDOT SHA SHELF TYPICAL 550.02.
- 23. THE CONTRACTOR SHALL REUSE THE EXISTING GRADED AGGREGATE BASE UNDER THE DRIVEWAY ENTRANCE IN ORDER TO SATISFY THE REQUIREMENTS FOR GRADED AGGREGATE PLACEMENT OUTLINED IN MDOT SHA STANDARDS MD-630.01, MD-630.02, AND MD-630.03.
- 24. THE CONTRACTOR SHALL MAINTAIN ADA COMPLIANT PEDESTRIAN ACCESS TO THE ADJACENT PROPERTIES AS DIRECTED BY THE ENGINEER. THE COST IS INCIDENTAL TO MOT ITEMS.
- 25. SAW CUTTING IS INCIDENTAL TO THE PERTINENT PAY ITEM.

INDEX OF SHEETS

SHEET NO.	DWG. NO.	DESCRIPTION
1	TI01	TITLE SHEET
2	GI01	INDEX OF SHEETS AND GENERAL NOTES
3–13	PS-01 TO PS-11	ROADWAY PLAN SHEETS
14	ES-01	EROSION AND SEDIMENT CONTROL GENERAL NOTES
15	SN-1	GENERAL NOTES AND PROPOSALS
16–26	SN-2.01 TO SN-2.11	SIGNING AND MARKING PLAN SHEETS
27	SN-11.01	INDEX OF QUANTITIES
28	SG-01	TRAFFIC SIGNALIZATION PLAN
29	SG-02	GENERAL INFORMATION SHEET

MAINTENANCE OF TRAFFIC NOTES:

- 1. ALL WORK SHALL BE PERFORMED IN ACCORDANCE WITH THE MDOT SHA STANDARD NUMBERS MD 104.00-01 THRU 104.06-27.
- 2. NO WORK IS TO BEGIN UNTIL TEMPORARY TRAFFIC CONTROL DEVICES INCLUDING, BUT NOT LIMITED TO, ADVANCED WARNING SIGNS, DRUMS, ARROW PANELS, ETC., ARE IN PLACE AND
- 3. ADVANCED NOTIFICATION OF SIDEWALK CLOSURES SHALL BE PROVIDED. A BARRIER THAT IS DETECTABLE BY A PERSON WITH A VISUAL DISABILITY SHALL BE PLACED ACROSS THE FULL WIDTH OF SIDEWALK.
- 4. WHERE PEDESTRIANS ARE DIRECTED TO CROSS THE OPPOSITE SIDE OF THE ROADWAY, APPROPRIATE ADVANCED SIGNING SHOULD BE PLACED AT THE INTERSECTIONS RATHER THAN MID-BLOCK CROSSINGS.
- 5. TRAFFIC CONTROL DEVICES AND OTHER CONSTRUCTION MATERIALS AND FEATURES SHALL NOT INTRUDE INTO THE USABLE WIDTH OF THE SIDEWALK, TEMPORARY PATHWAY OR OTHER PEDESTRIAN FACILITY.
- 6. PROVIDE ACCESS TO ALL ENTRANCES AND COORDINATE DRIVEWAY ACCESS WITH ADJACENT PROPERTY OWNERS.
- 7. WHERE SIDEWALK IS PRESENT ON BOTH SIDES OF THE STREET, ONE SIDE SHALL REMAIN OPEN.
- 8. CONTRACTOR SHALL START AND COMPLETE ONE BLOCK, ON ONE SIDE OF THE ROADWAY AT A TIME BEFORE PROCEEDING TO THE NEXT BLOCK IN ORDER TO MINIMIZE IMPACTS ON PEDESTRIAN TRAFFIC AND ON-STREET PARKING. CLOSING EXISTING ON-STREET PARKING TO THE PUBLIC SHALL BE LIMITED TO THE ONE BLOCK WORK AREA. CLOSED PARKING LANES MAY BE USED FOR TEMPORARY TRAFFIC CONTROL.
- 9. CONTRACTOR SHALL FOLLOW THE REQUIREMENTS FOR TEMPORARY LANE AND SHOULDER CLOSURES AS SET FORTH IN THE TRAFFIC CONTROL PLAN SPECIAL PROVISION 104.01.

SEQUENCE OF CONSTRUCTION

GENERAL NOTES

- 1. THE CONTRACTOR SHALL NOTIFY THE MDOT SHA QUALITY ASSURANCE DIVISION (QAD) AT (410) 365-0164 A MINIMUM OF SEVEN (7) DAYS PRIOR TO ANY EARTH DISTURBANCE TO SET UP A PRE-CONSTRUCTION MEETING BETWEEN THE PROJECT REPRESENTATIVES AND THE QAD.
- 2. CONSTRUCT SIDEWALK/RAMP/DRIVEWAY IMPROVEMENTS AND PERMANENTLY STABILIZE ALL DISTURBED AREAS FOLLOWING THE COMPLETION OF THE PROPOSED IMPROVEMENT. USE SAME-DAY STABILIZATION PRACTICES FOR THIS PROJECT. IN ORDER TO COMPLY WITH THE SAME-DAY STABILIZATION PRACTICES, NO DISTURBED AREAS SHALL BE LEFT UNSTABILIZED AT THE END OF ANY WORK DAY.
- 3. UPON COMPLETION OF IMPROVEMENTS AND PERMANENT STABILIZATION, NOTIFY THE QAD TO OBTAIN FINAL ACCEPTANCE BY THE ADMINISTRATION.

BEST MANAGEMENT PRACTICES FOR WORKING IN NONTIDAL WETLANDS, WETLAND BUFFERS, WATERWAYS, AND 100-YEAR **FLOODPLAINS**

- 1) NO EXCESS FILL, CONSTRUCTION MATERIAL, OR DEBRIS SHALL BE STOCKPILED OR STORED IN NONTIDAL WETLANDS, NONTIDAL WETLAND BUFFERS, WATERWAYS, OR THE 100-YEAR FLOODPLAIN.
- 2) PLACE MATERIALS IN A LOCATION AND MANNER WHICH DOES NOT ADVERSELY IMPACT SURFACE OR SUBSURFACE WATER FLOW INTO OR OUT OF NONTIDAL WETLANDS, NONTIDAL WETLAND BUFFERS, WATERWAYS, OR THE 100-YEAR FLOODPLAIN.
- 3) DO NOT USE THE EXCAVATED MATERIAL AS BACKFILL IF IT CONTAINS WASTE METAL PRODUCTS, UNSIGHTLY DEBRIS, TOXIC MATERIAL, OR ANY OTHER DELETERIOUS SUBSTANCE. IF ADDITIONAL BACKFILL IS REQUIRED, USE CLEAN MATERIAL FREE OF WASTE METAL PRODUCTS, UNSIGHTLY DEBRIS, TOXIC MATERIAL, OR ANY OTHER ELETERIOUS SUBSTANCE.
- 4) PLACE HEAVY EQUIPMENT ON MATS OR SUITABLY OPERATE THE EQUIPMENT TO PREVENT DAMAGE TO NONTIDAL WETLANDS, NONTIDAL WETLAND BUFFERS, WATERWAYS, OR THE 100-YEAR FLOODPLAIN.
- 5) REPAIR AND MAINTAIN ANY SERVICEABLE STRUCTURE OR FILL SO THERE IS NO PERMANENT LOSS OF NONTIDAL WETLANDS, NONTIDAL WETLAND BUFFERS, OR WATERWAYS, OR PERMANENT MODIFICATION OF THE 100-YEAR FLOODPLAIN IN EXCESS OF THAT LOST UNDER THE ORIGINALLY AUTHORIZED STRUCTURE OR FILL.
- 6) RECTIFY ANY NONTIDAL WETLANDS, WETLAND BUFFERS, WATERWAYS, OR 100-YEAR FLOODPLAIN TEMPORARILY IMPACTED BY ANY CONSTRUCTION.
- 7) ALL STABILIZATION IN THE NONTIDAL WETLAND AND NONTIDAL WETLAND BUFFER SHALL CONSIST OF THE FOLLOWING SPECIES: ANNUAL RYEGRASS (LOLIUM MULTIFLORUM), MILLET (SETARIA ITALICA), BARLEY (HORDEUM SP.), OATS (UNIOLA SP.), AND/OR RYE (SECALE CEREALE). THESE SPECIES WILL ALLOW FOR THE STABILIZATION OF THE SITE WHILE ALSO ALLOWING FOR THE VOLUNTARY REVEGETATION OF NATURAL WETLAND SPECIES. OTHER NON-PERSISTENT VEGETATION MAY BE ACCEPTABLE, BUT MUST BE APPROVED BY THE NONTIDAL WETLANDS AND WATERWAYS DIVISION. KENTUCKY 31 FESCUE SHALL NOT BE UTILIZED IN WETLAND OR BUFFER AREAS. THE AREA SHOULD BE SEEDED AND MULCHED TO REDUCE EROSION AFTER CONSTRUCTION ACTIVITIES HAVE BEEN COMPLETED.
- 8) AFTER INSTALLATION HAS BEEN COMPLETED, MAKE POST-CONSTRUCTION GRADES AND ELEVATIONS THE SAME AS THE ORIGINAL GRADES AND ELEVATIONS IN TEMPORARILY IMPACTED AREAS.
- 9) TO PROTECT AQUATIC SPECIES, IN-STREAM WORK IS PROHIBITED AS DETERMINED BY THE CLASSIFICATION OF THE STREAM: USE IV WATERS: IN-STREAM WORK SHALL NOT BE CONDUCTED DURING THE PERIOD MARCH 1 THROUGH MAY 31. INCLUSIVE, DURING ANY YEAR.
- 10) STORMWATER RUNOFF FROM IMPERVIOUS SURFACES SHALL BE CONTROLLED TO PREVENT THE WASHING OF DEBRIS INTO THE WATERWAY.
- 11) CULVERTS SHALL BE CONSTRUCTED AND ANY RIPRAP PLACED SO AS NOT TO OBSTRUCT THE MOVEMENT OF AQUATIC SPECIES, UNLESS THE PURPOSE OF THE ACTIVITY IS TO IMPOUND WATER.



INNOVATIVE CONTRACTING DIVISION




MD 725 (MAIN STREET) FROM WEST OF SERVICE LANE TO EAST OF GOVERNOR ODEN BOWIE DRIVE SIDEWALKS


INDEX OF SHEETS AND GENERAL NOTES DATE APRIL 12, 2022 CONTRACT NO. PGA115133 SCALE NTS


			00111111101	1 0,7 (11010
DESIGNED BY	HWP	COUNT	Y PRINCE	GEORGE'S
DRAWN BY	SAZ	 LOGMIL	 E	
CHECKED BY	REH	HORIZC	NTAL SCALE	N/A
MDE/PRD	20-PR-0006-03	VERTICA	AL SCALE	N/A


DRAWING NO. GI-01 OF 01 SHEET NO. 2 OF 29




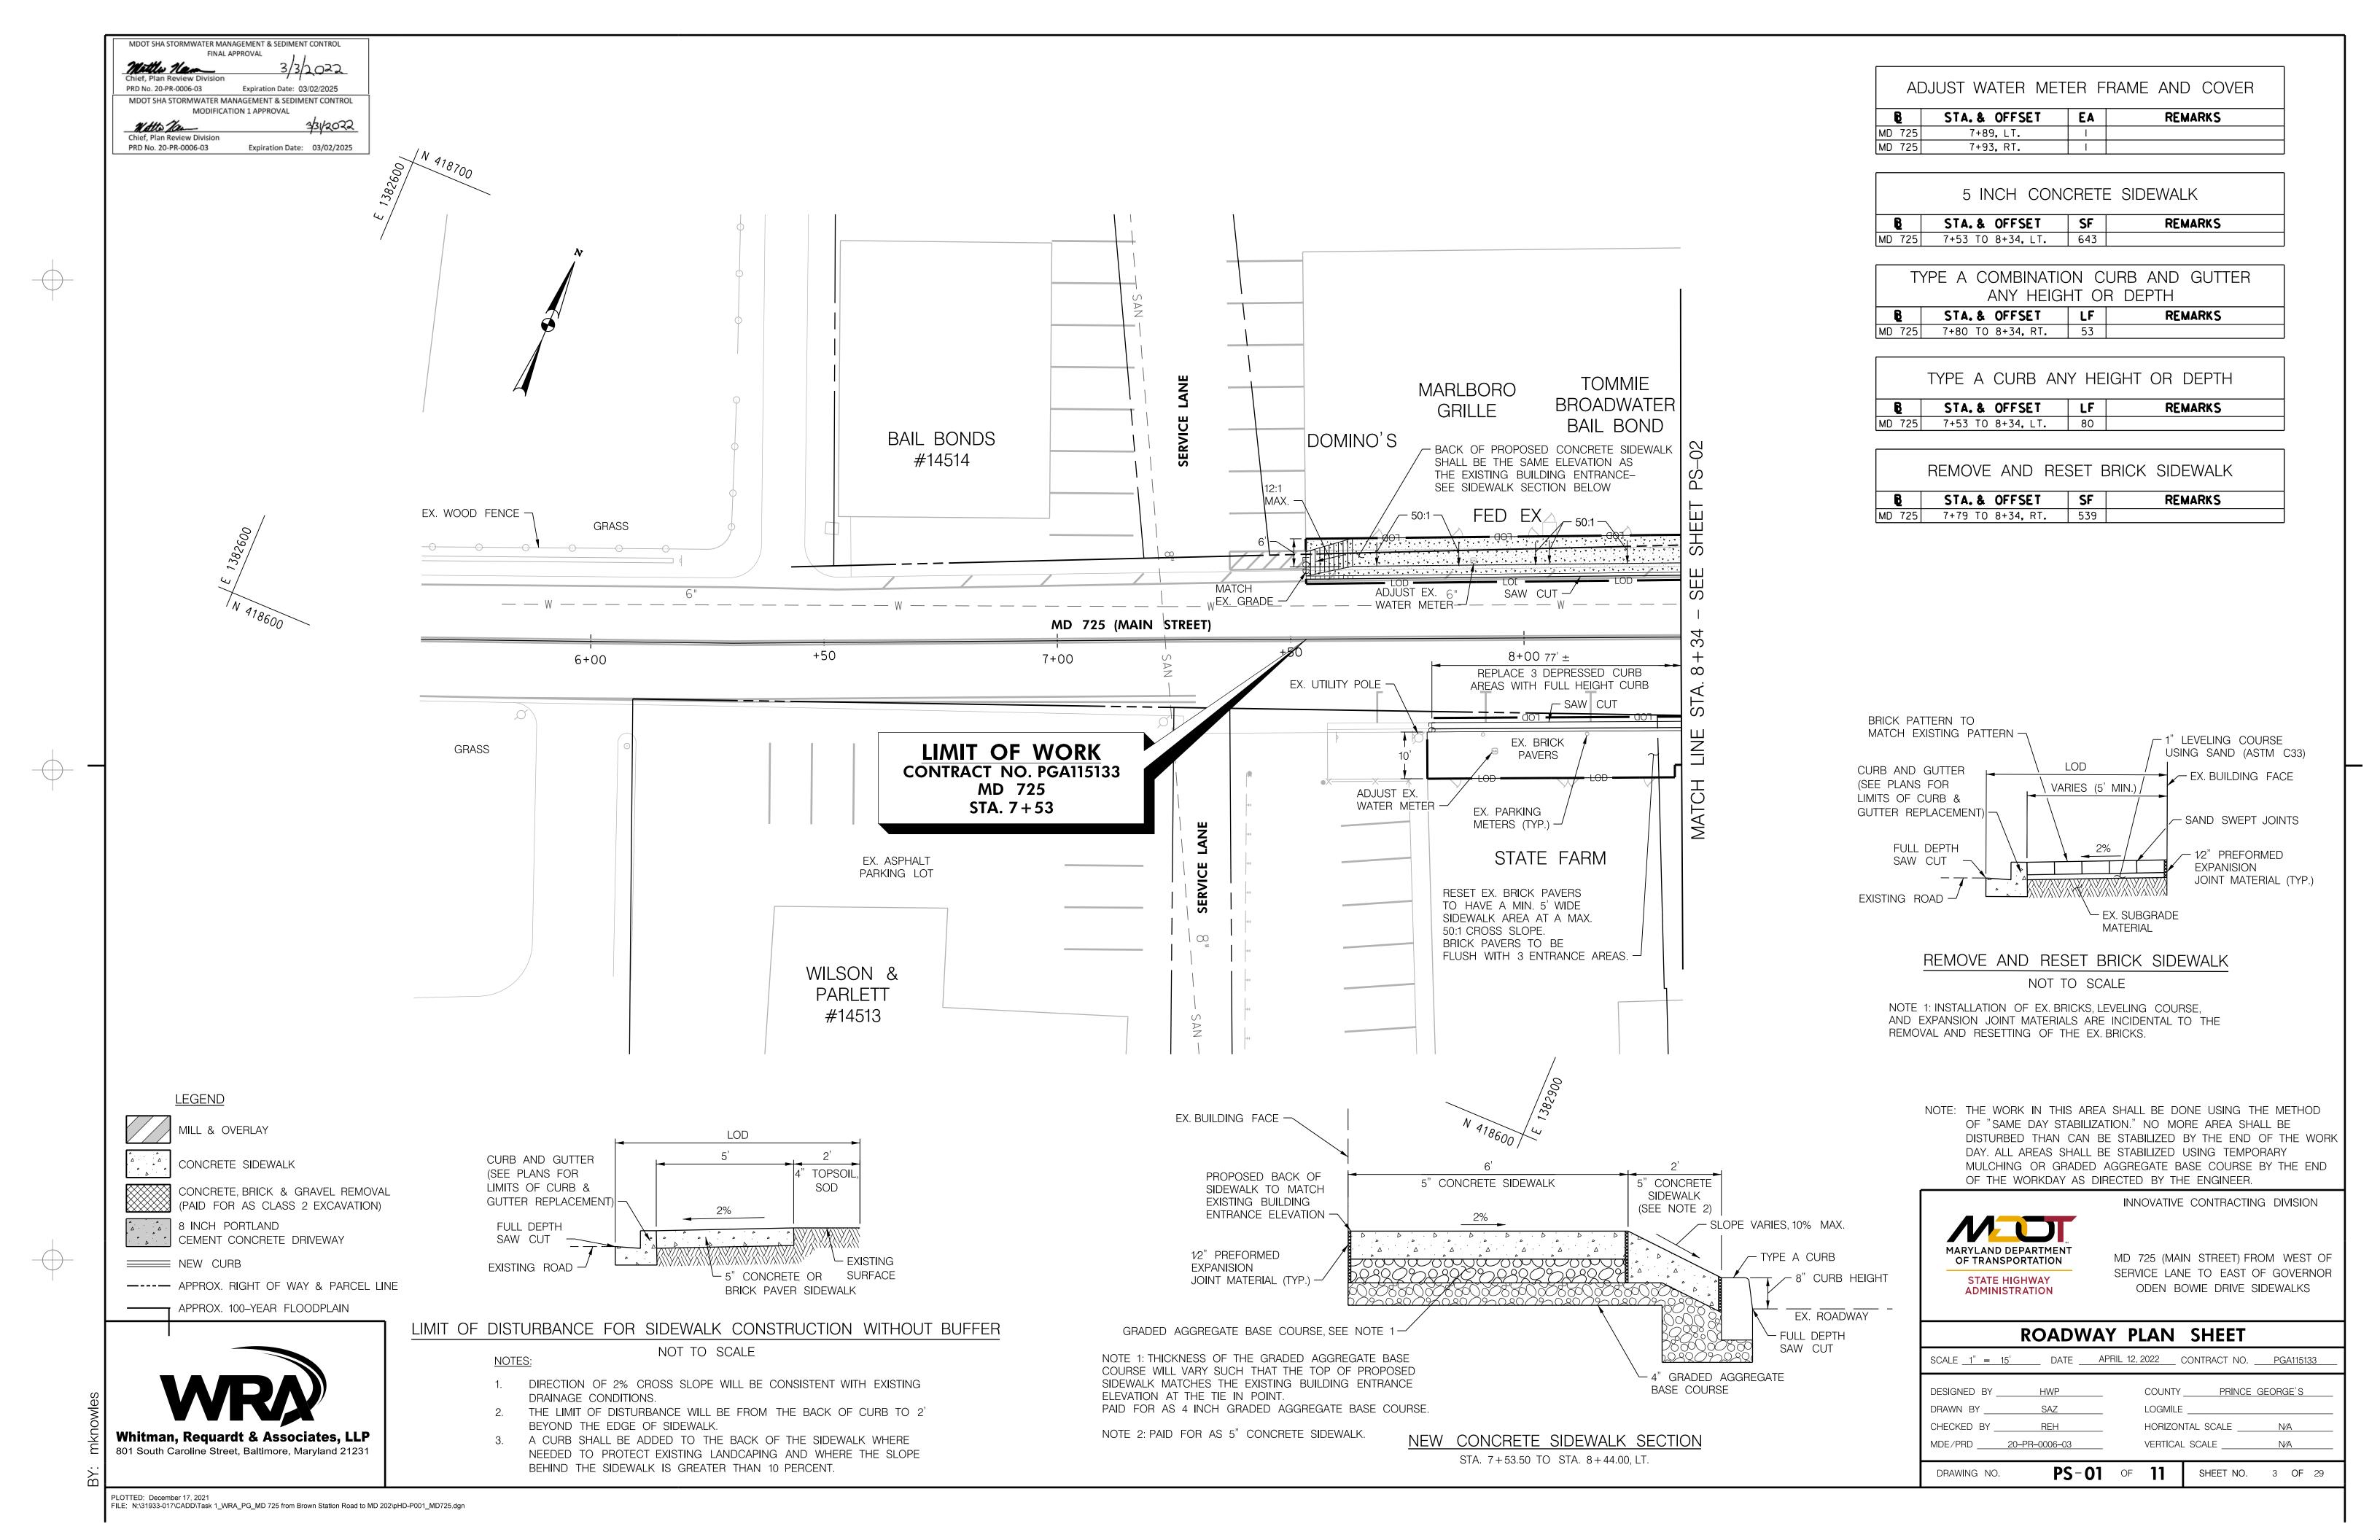

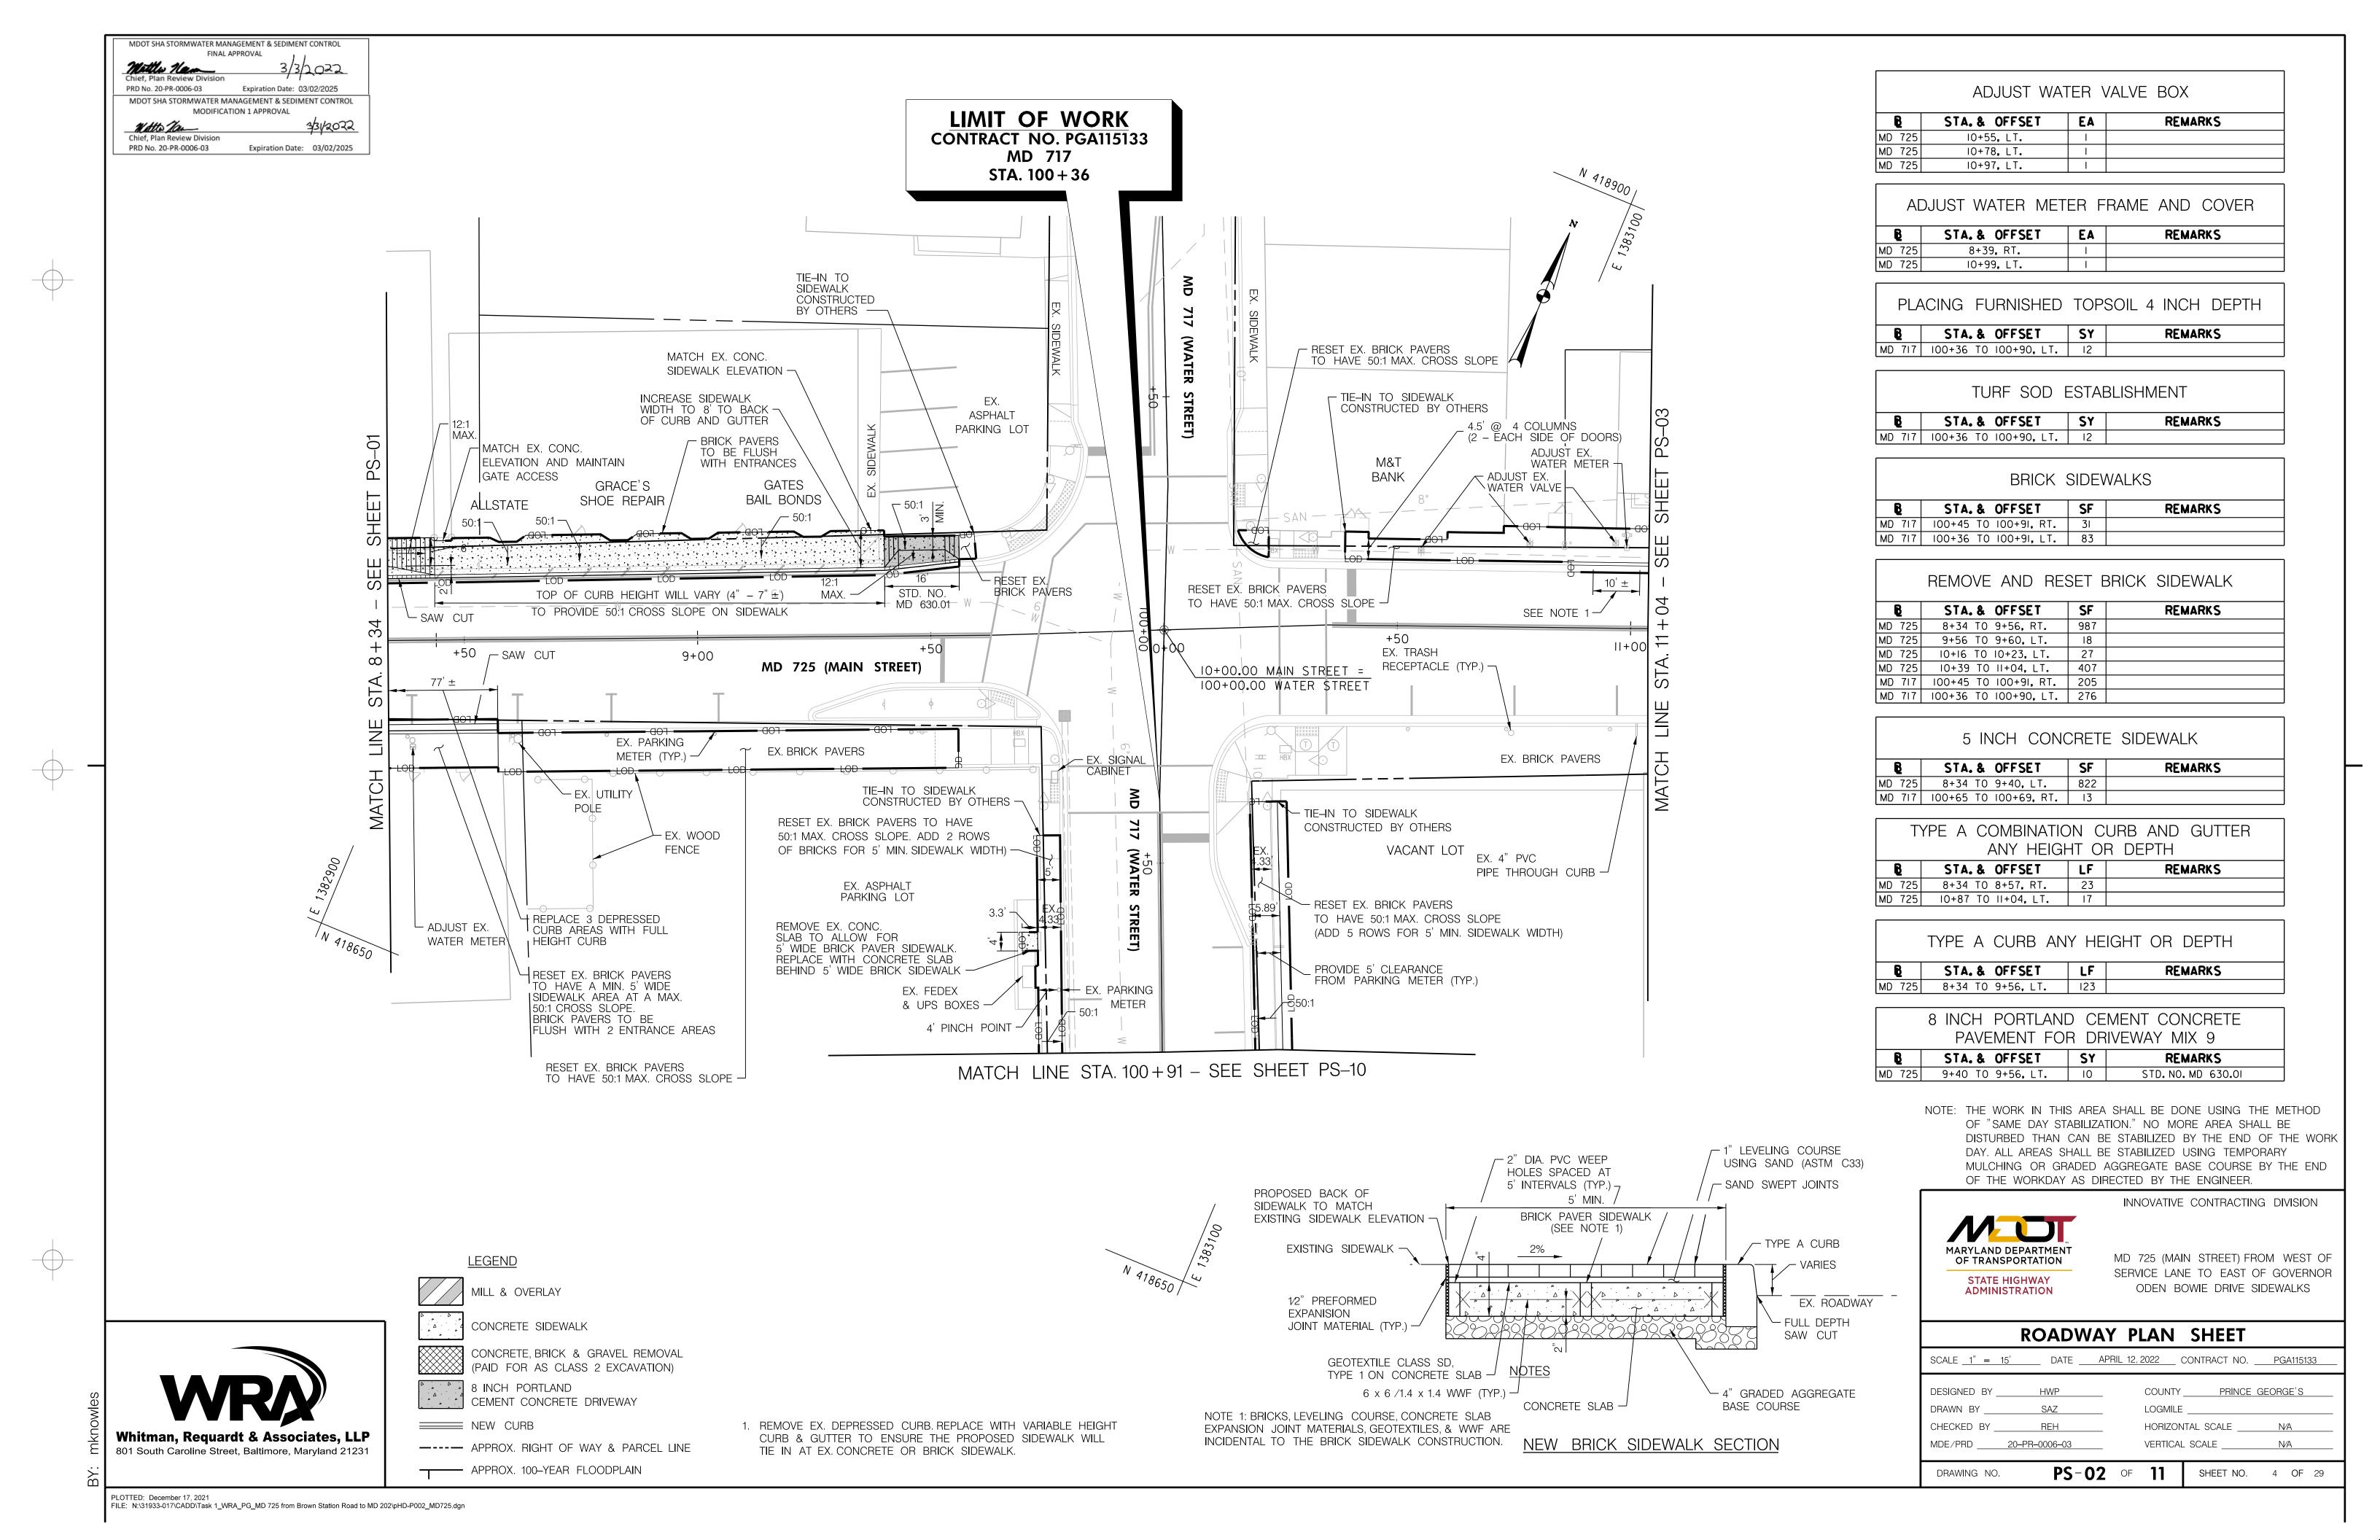

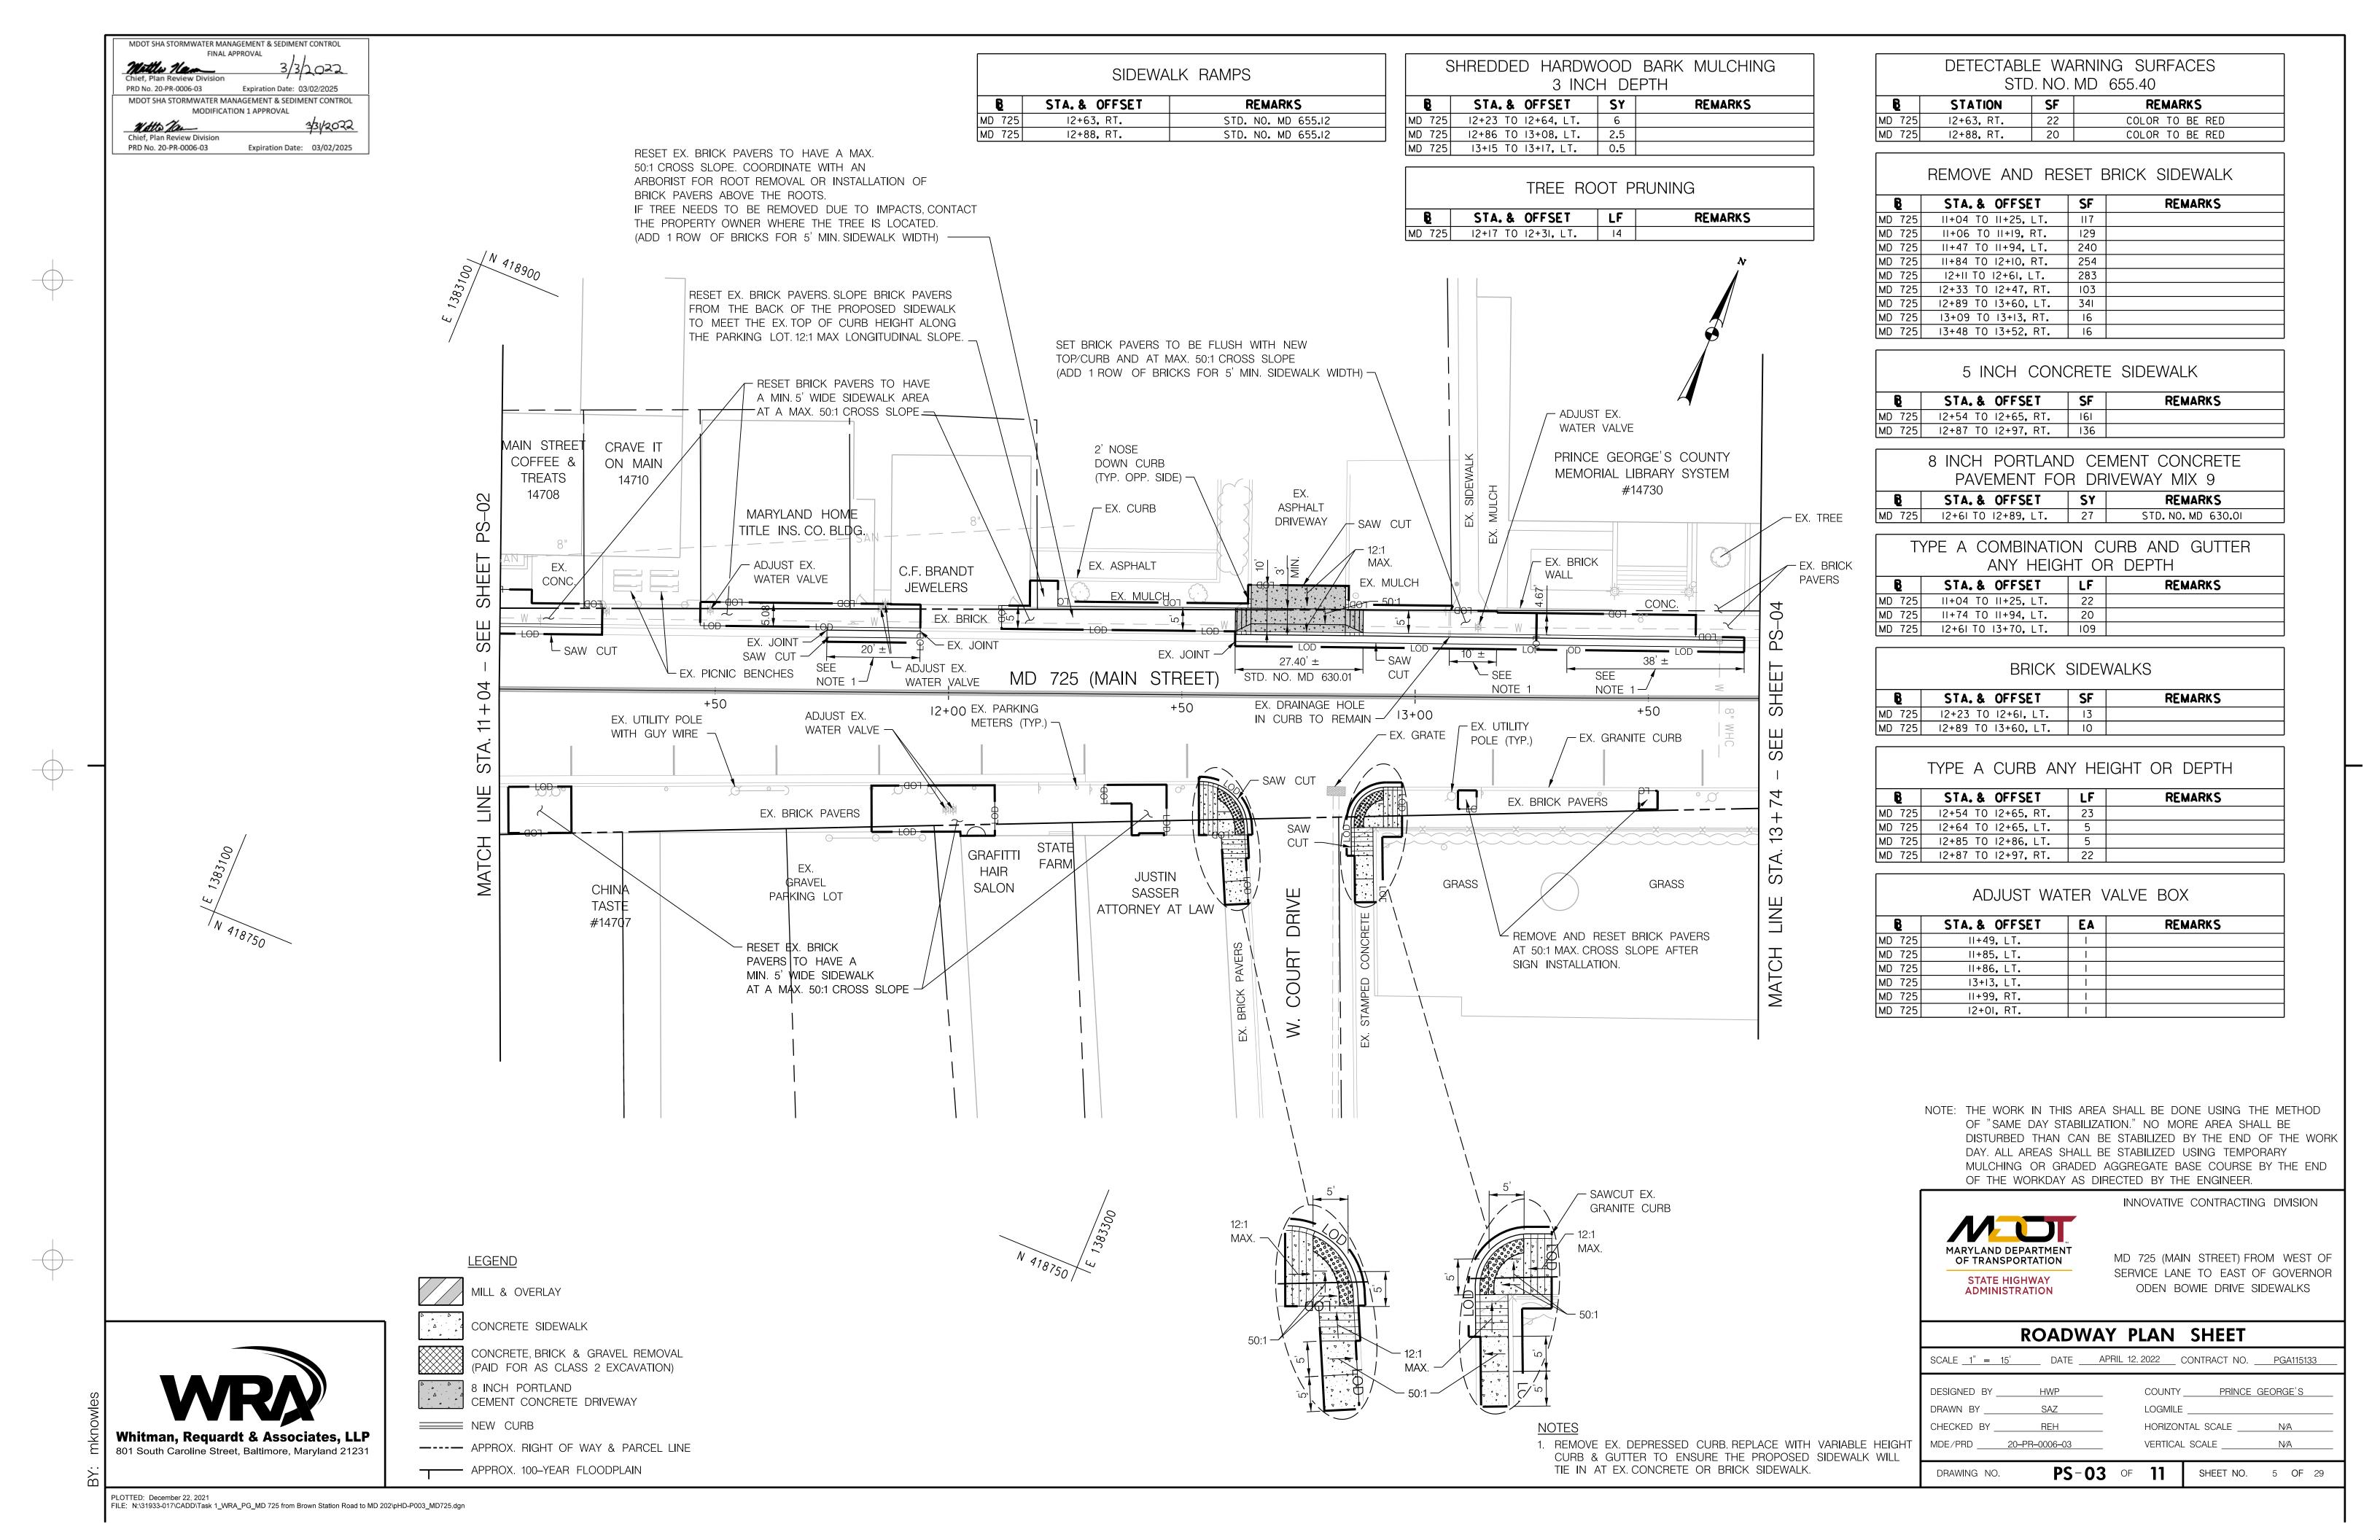

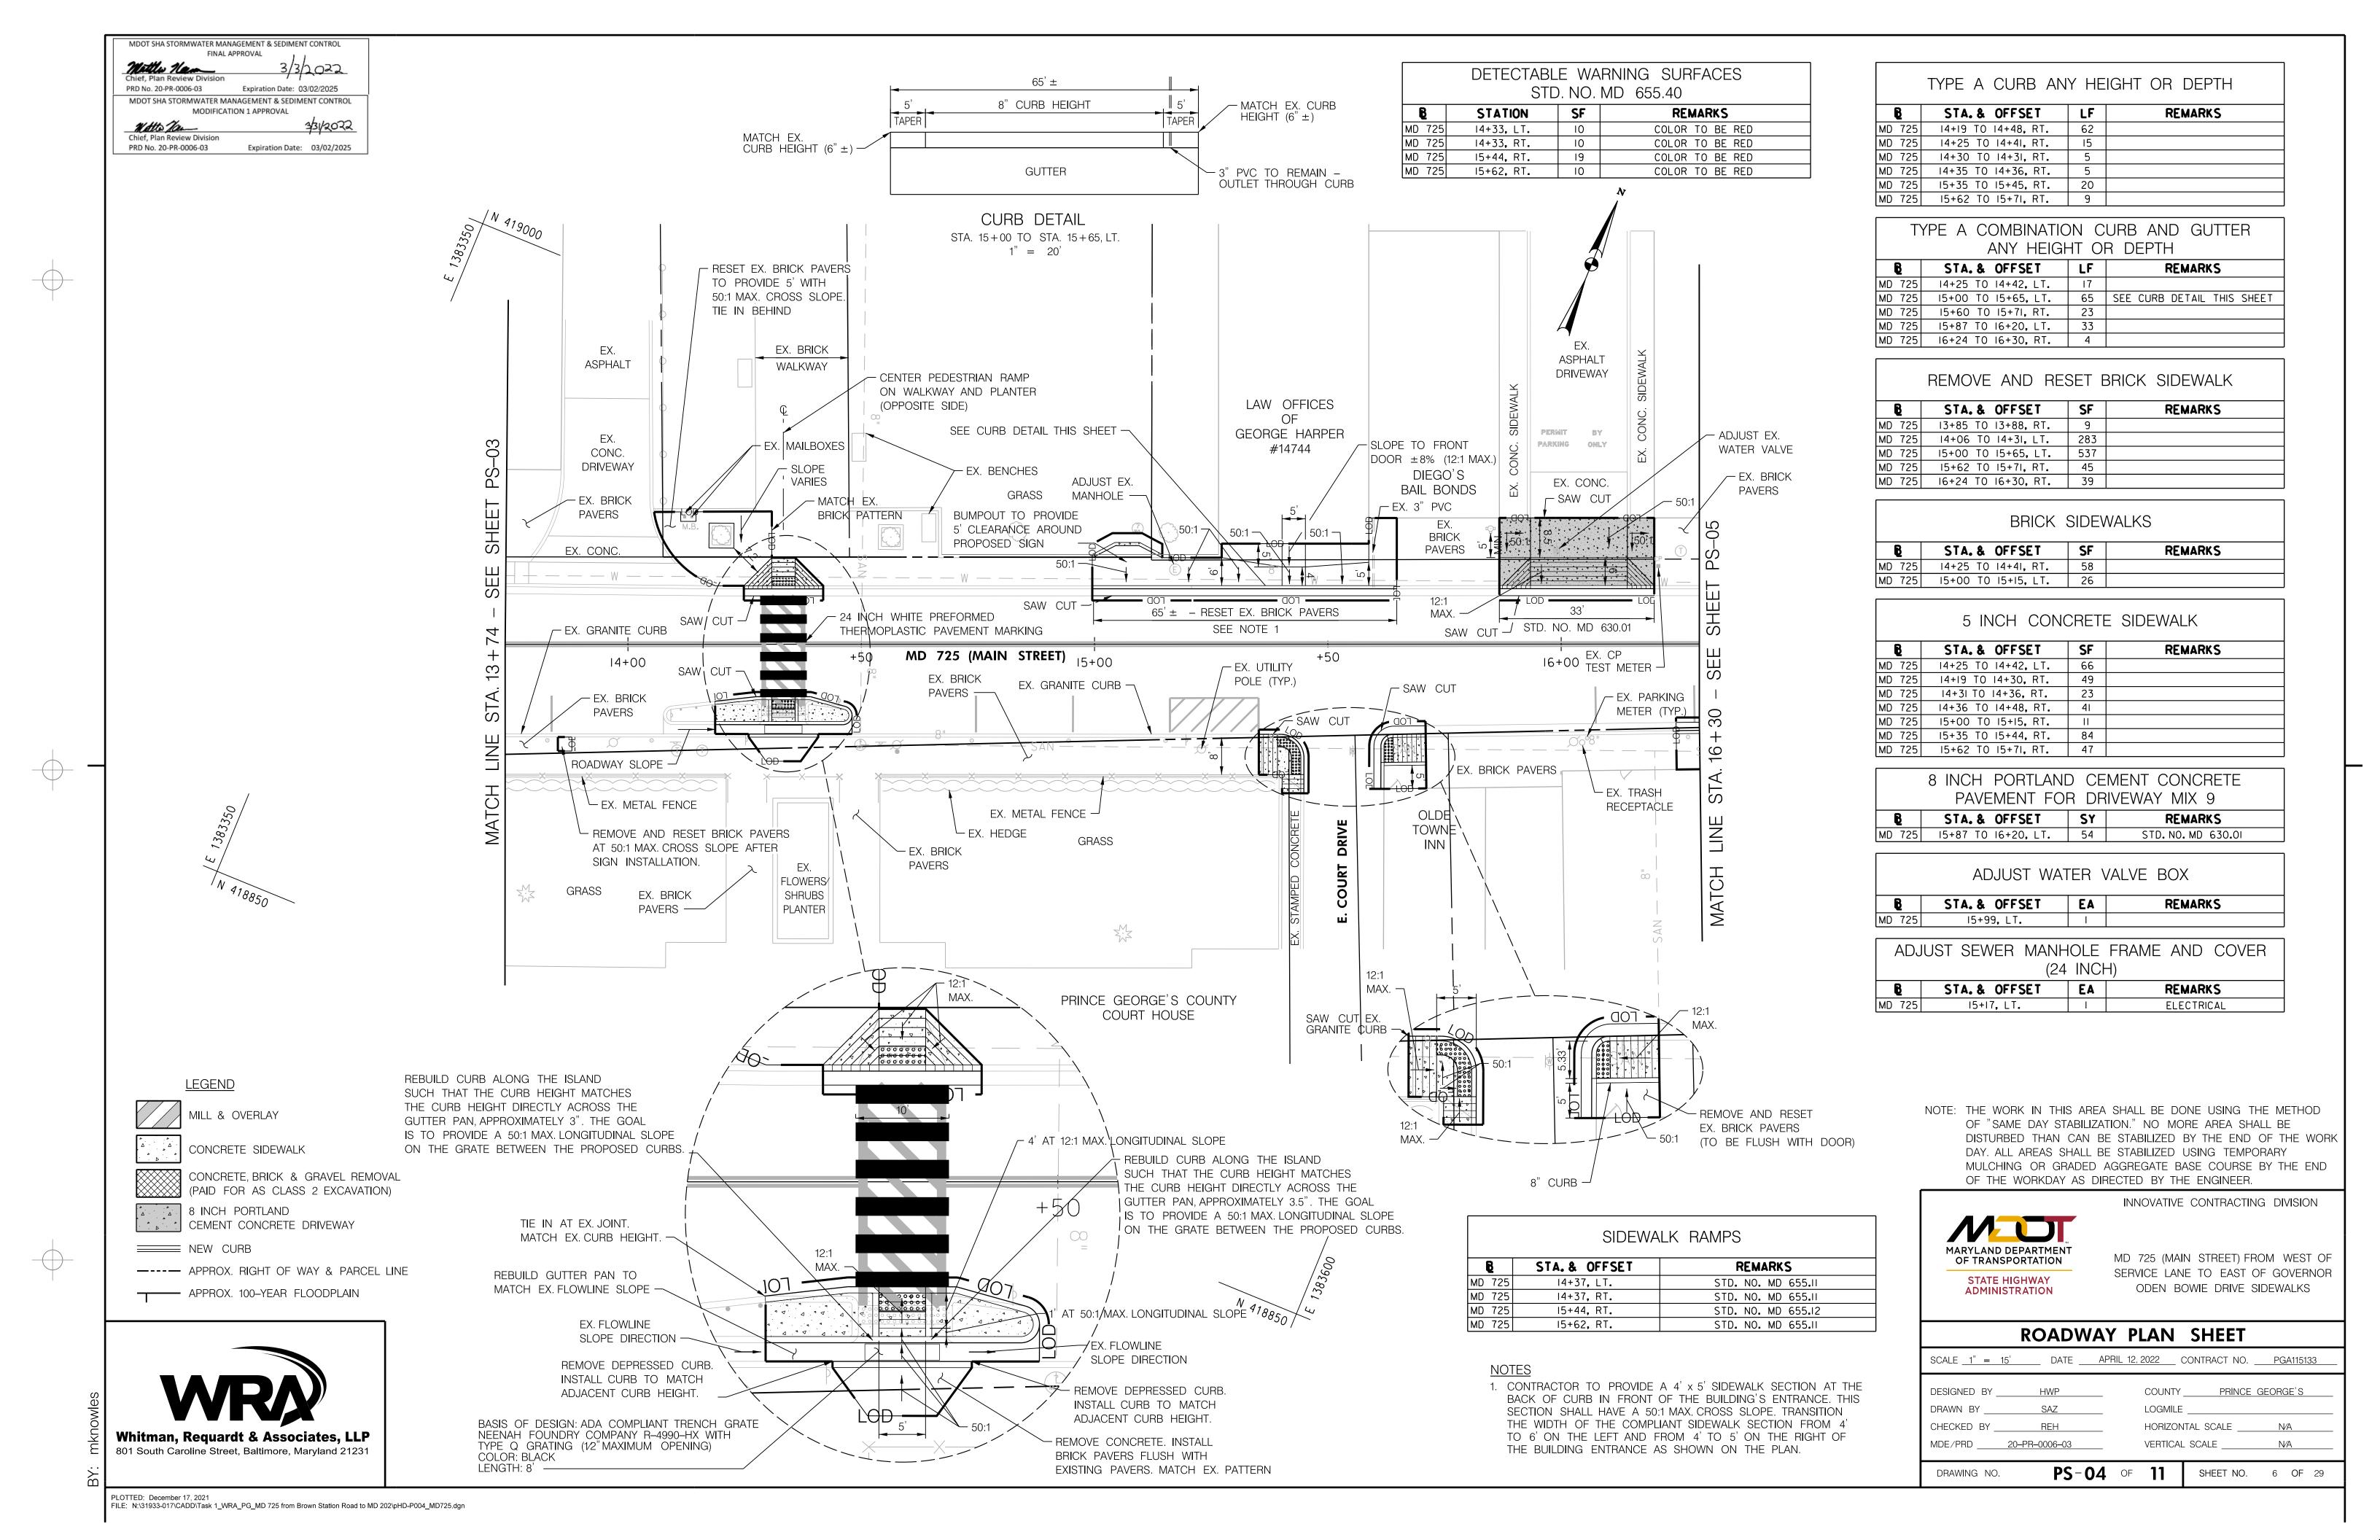

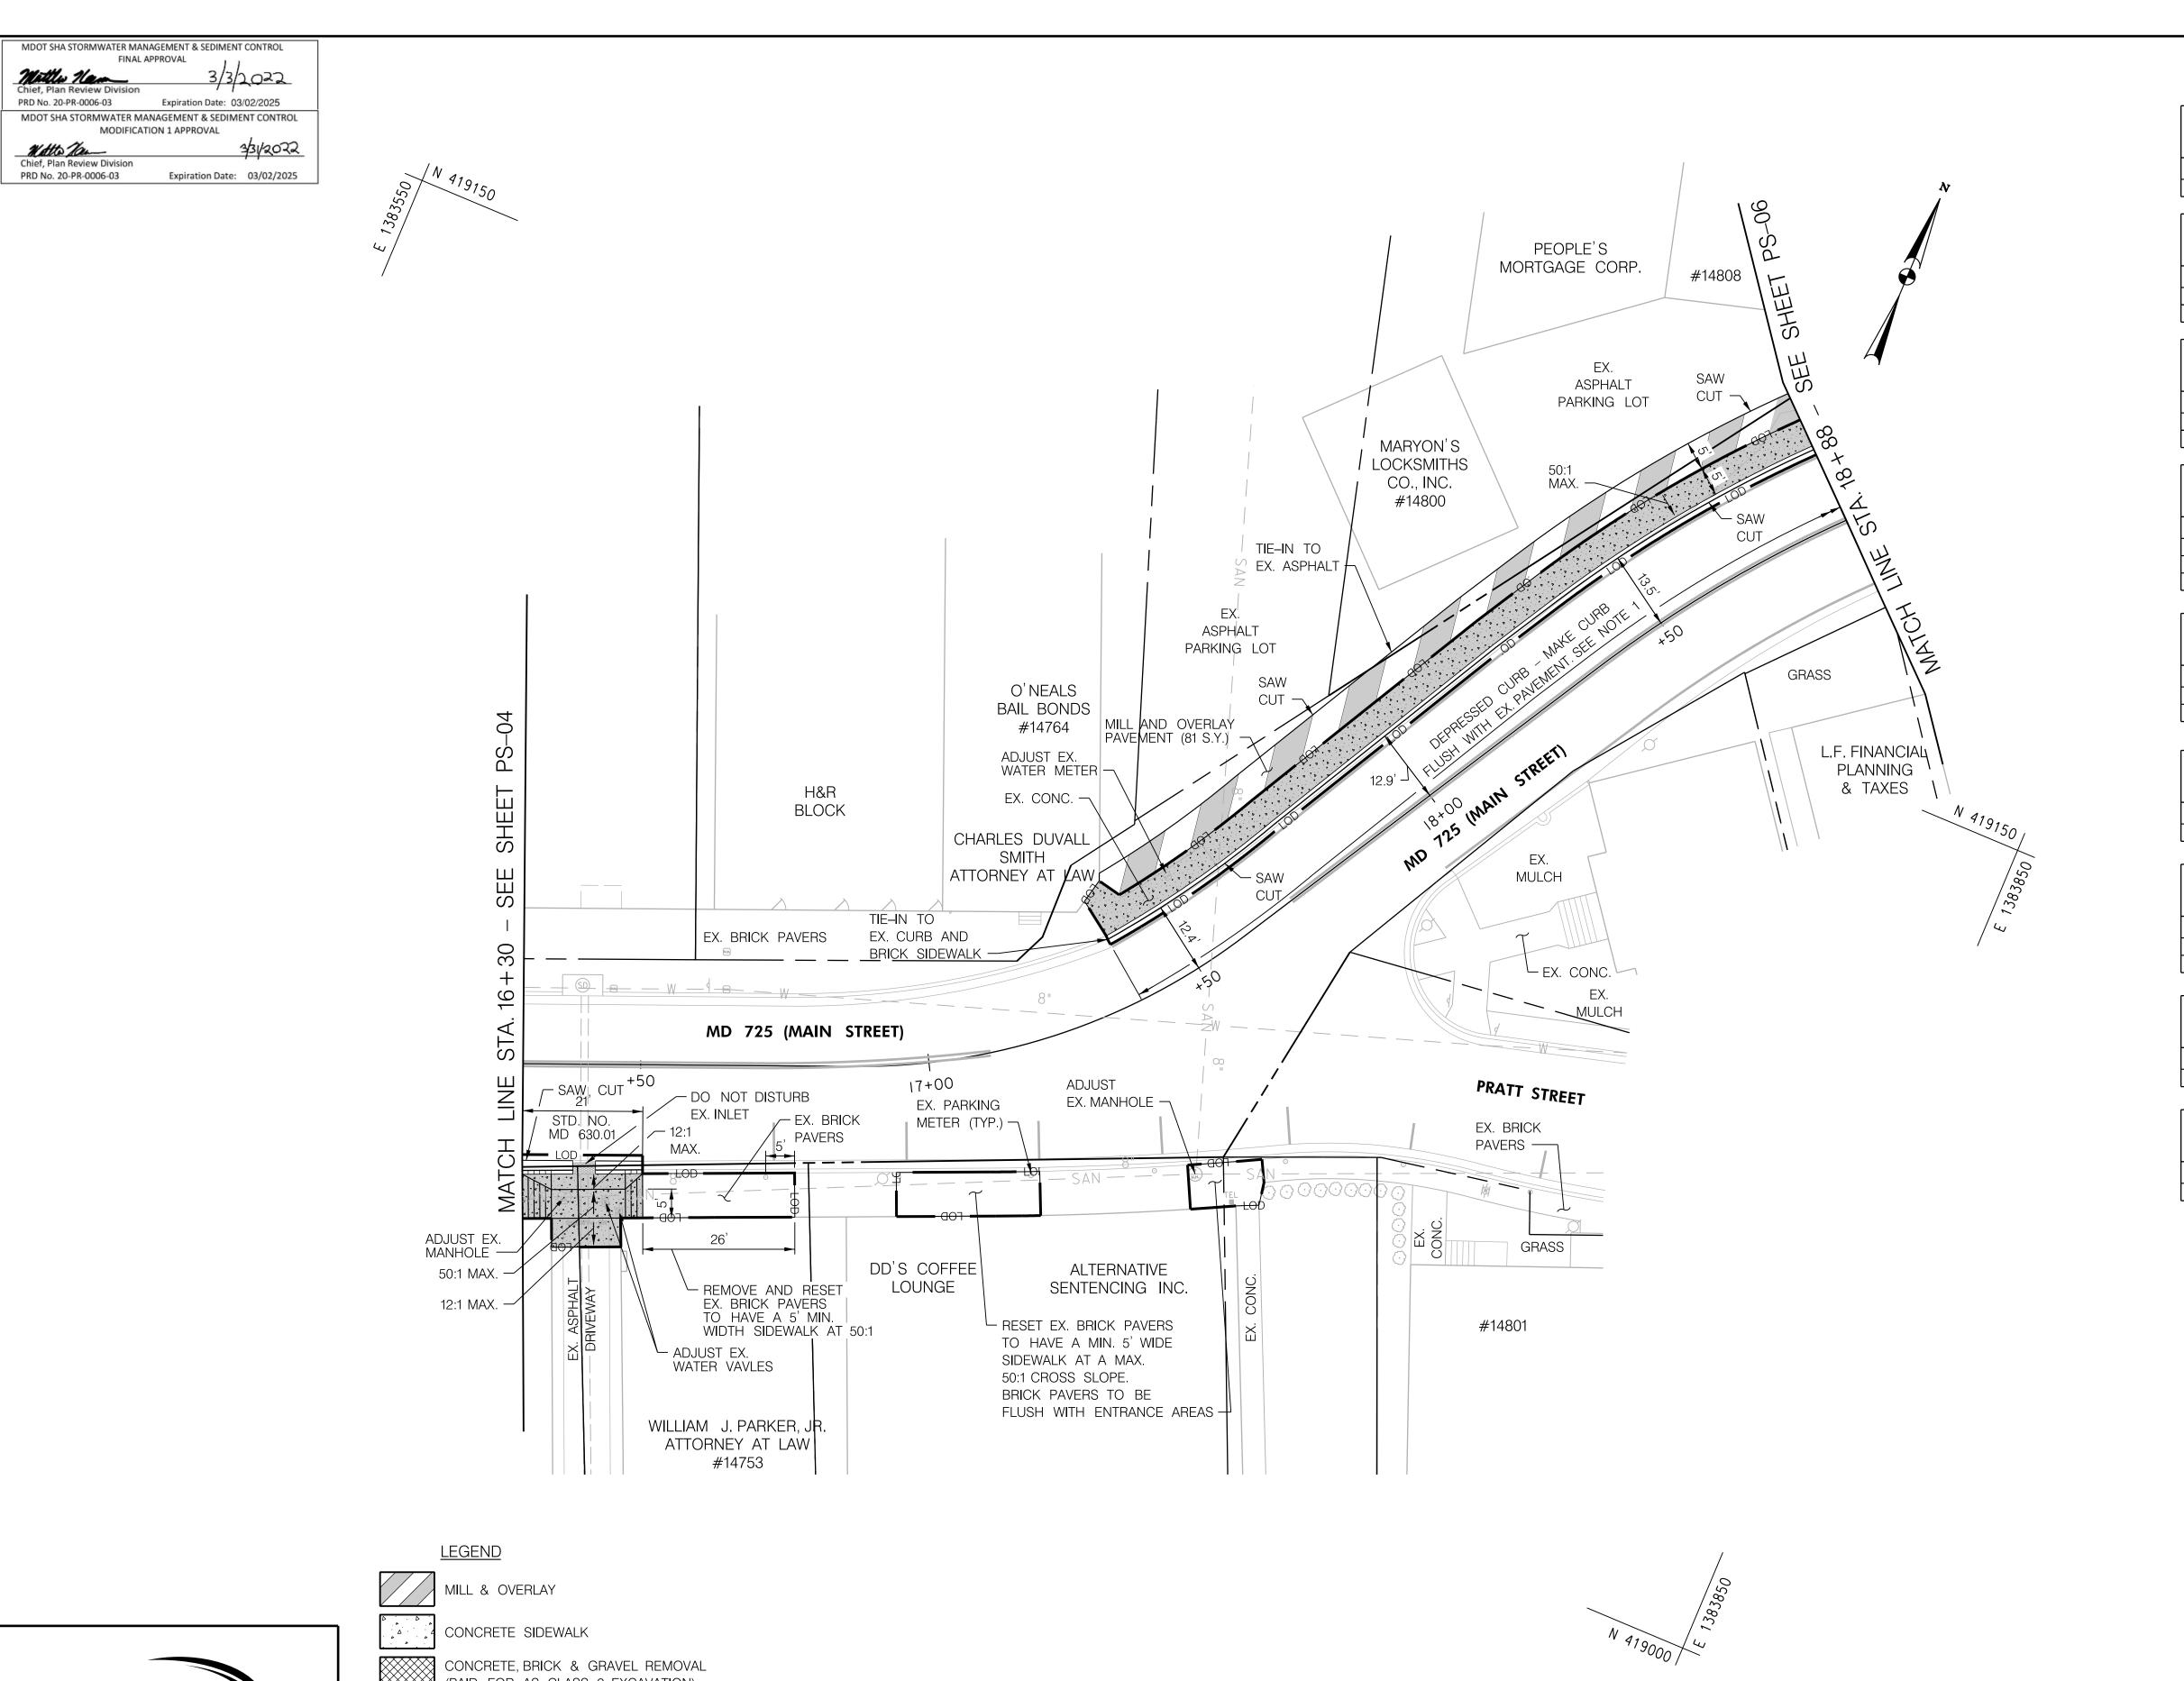

ADJUST WATER METER FRAME AND COVER

B STA. & OFFSET EA REMARKS

MD 725 17+55, LT. 1

ADJUST WATER VALVE BOX

STA. & OFFSET	EA	REMARKS	
MD 725	I6+34, RT.		
MD 725	I6+36, RT.		

ADJUST SEWER MANHOLE FRAME AND COVER (24 INCH)

B STA. & OFFSET EA REMARKS

MD 725 I6+37, RT. I SANITARY

MD 725 I7+35, RT. I SANITARY

TYPE A COMBINATION CURB AND GUTTER
ANY HEIGHT OR DEPTH

STA. & OFFSET	LF	REMARKS
MD 725	16+30 TO 16+39, RT.	9
MD 725	16+42 TO 16+50, RT.	8

TYPE A CURB ANY HEIGHT OR DEPTH

STA. & OFFSET LF REMARKS

MD 725 17+38 TO 18+88, LT. 149 SEE NOTE I

8 INCH PORTLAND CEMENT CONCRETE
PAVEMENT FOR DRIVEWAY MIX 9

8 STA. & OFFSET SY REMARKS
MD 725 | 16+30 TO 16+50, RT. | 25 STD. NO. MD 630.01
MD 725 | 17+37 TO 18+88, LT. | 86

STANDARD MILLING ASPHALT PAVEMENT
OVER 1 INCH TO 2.5 INCH DEPTH

STA. & OFFSET SY REMARKS
MD 725 17+43 TO 18+88, LT. 81

SUPERPAVE ASPHALT MIX 9.5MM FOR SURFACE PG 64E-22, LEVEL 2

B STA. & OFFSET TON REMARKS

MD 725 17+43 TO 18+88, LT. 10

NOTE: THE WORK IN THIS AREA SHALL BE DONE USING THE METHOD OF "SAME DAY STABILIZATION." NO MORE AREA SHALL BE DISTURBED THAN CAN BE STABILIZED BY THE END OF THE WORK DAY. ALL AREAS SHALL BE STABILIZED USING TEMPORARY MULCHING OR GRADED AGGREGATE BASE COURSE BY THE END OF THE WORKDAY AS DIRECTED BY THE ENGINEER.

INNOVATIVE CONTRACTING DIVISION



DRAWING NO.

MD 725 (MAIN STREET) FROM WEST OF SERVICE LANE TO EAST OF GOVERNOR ODEN BOWIE DRIVE SIDEWALKS

PS-05 OF **11** | SHEET NO. 7 OF 29

ROADWAY PLAN SHEET

SCALE <u>1" = 1</u>	<u>5'</u> DATE	APRIL 12, 2022	_ CONTRACT NO.	PGA115133
DESIGNED BY		COUN'		GEORGE'S
CHECKED BY	REH	 HORIZ	ONTAL SCALE	N/A
MDE/PRD	20-PR-0006-03	VERTIO	CAL SCALE	N/A

Whitman, Requardt & Associates, LLP 801 South Caroline Street, Baltimore, Maryland 21231 CONCRETE SIDEWALK

CONCRETE, BRICK & GRAVEL REMOVAL
(PAID FOR AS CLASS 2 EXCAVATION)


8 INCH PORTLAND
CEMENT CONCRETE DRIVEWAY


NEW CURB


APPROX. RIGHT OF WAY & PARCEL LINE
APPROX. 100–YEAR FLOODPLAIN

1. CONTRACTOR TO INSTALL CURB FLUSH WITH THE EXISTING ROADWAY AND SIDEWALK AT A 50:1 MAX. CROSS SLOPE TO ENSURE POSITIVE DRAINAGE.



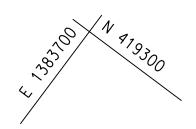

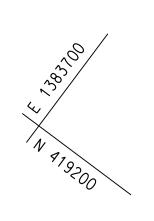

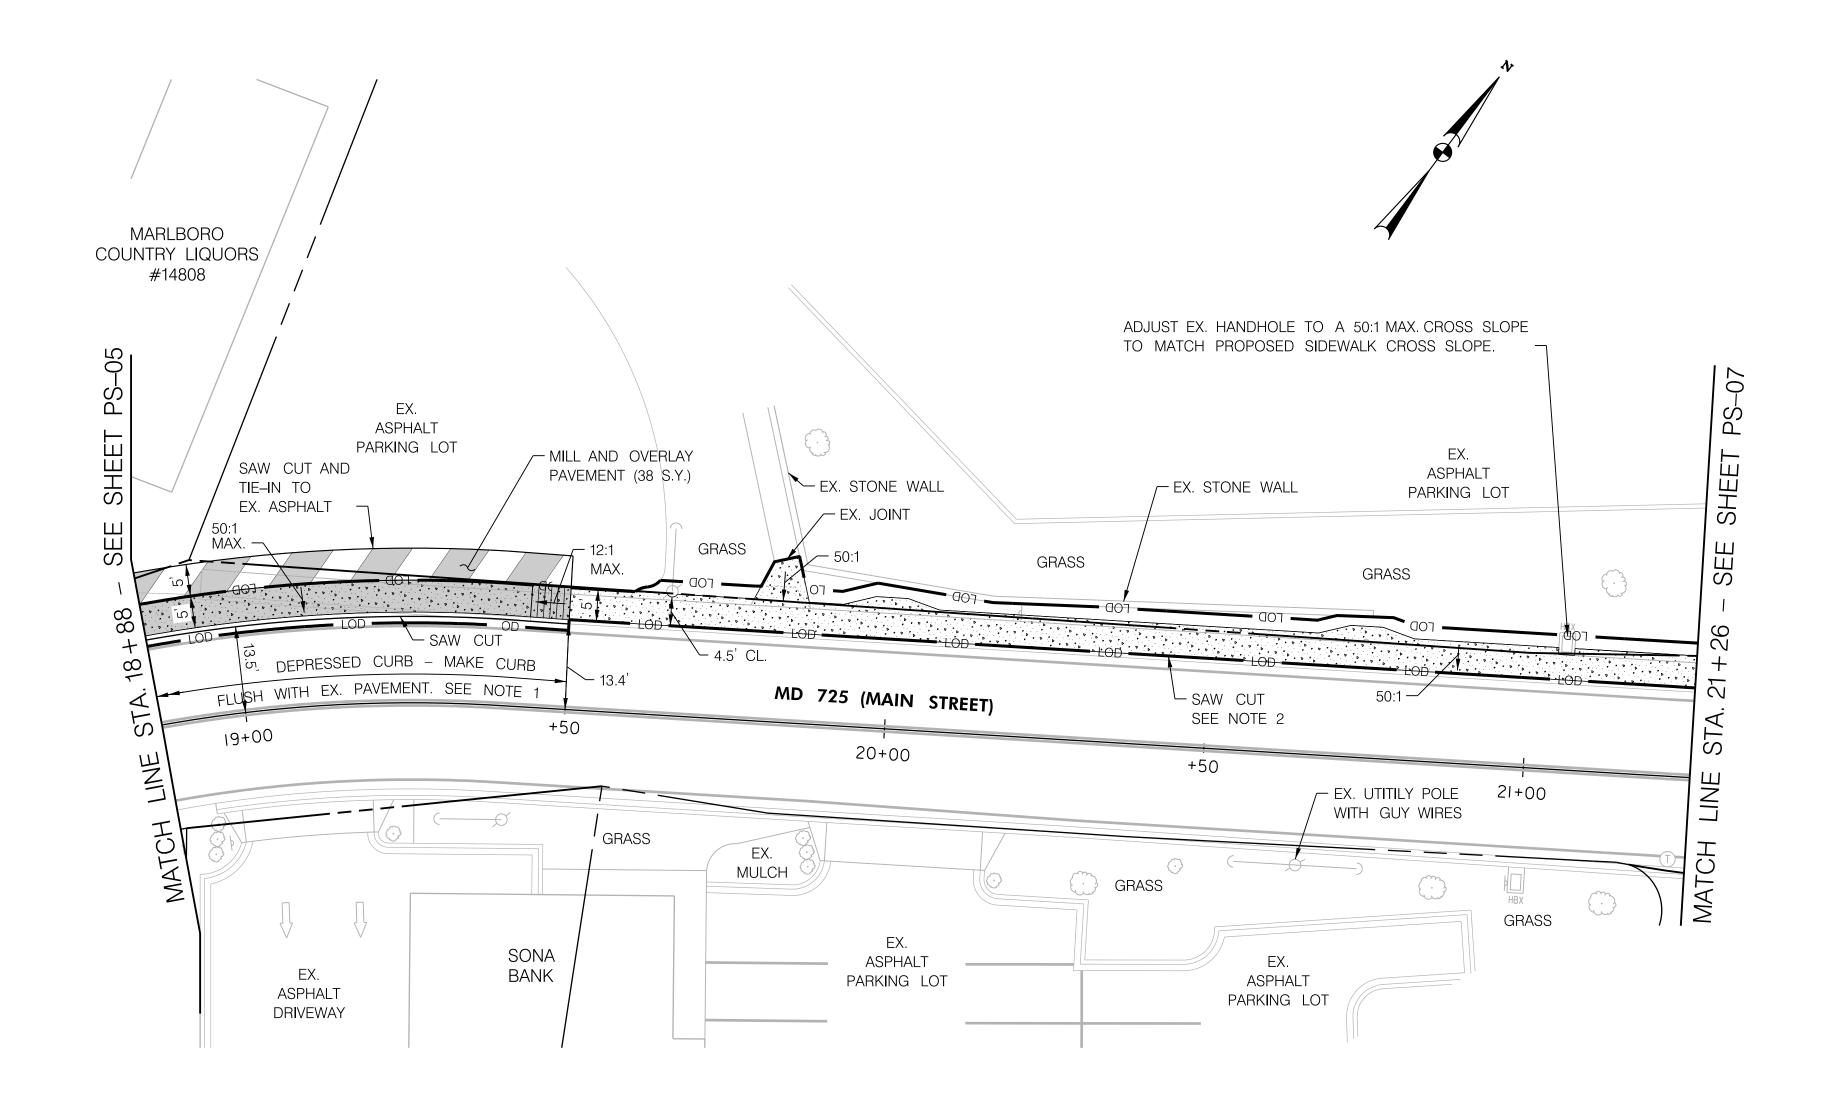

TURF SOD ESTABLISHMENT B STA. & OFFSET SY REMARKS MD 725 | 19+60 TO 19+79, LT. | 3 MD 725 | 19+87 TO 21+26, LT. | 31

PLACING FURNISHED TOPSOIL 4 INCH DEPTH B STA. & OFFSET SY REMARKS MD 725 | 19+60 TO 19+79, LT. | 3 MD 725 | 19+87 TO 21+26, LT. | 31

	ADJUST EXIST	TING	HANDHOLE
B	STA. & OFFSET	EA	REMARKS
MD 725	21+06, LT.	I	

	8 INCH PORTLAND PAVEMENT FOF		
B	STA. & OFFSET	SY	REMARKS
MD 725	18+88 TO 19+50, LT.	38	

	5 INCH CONC	CRETE	E SIDEWALK
B	STA. & OFFSET	SF	REMARKS
MD 725	19+50 TO 21+26, LT.	949	

	TYPE A	CURB AN	IY HE	IGHT OR DEPTH
B	STA. &	OFFSET	LF	REMARKS
MD 725	18+88 TO	19+50, LT.	66	

	STANDARD MILLIN OVER 1 INCH		
B	STA. & OFFSET	SY	REMARKS
MD 725	18+88 TO 19+50, LT.	38	

	SUPERPAVE ASPH SURFACE PG		
B	STA.& OFFSET	TON	REMARKS
MD 725	18+88 TO 19+50, LT.	4	

NOTE: THE WORK IN THIS AREA SHALL BE DONE USING THE METHOD OF "SAME DAY STABILIZATION." NO MORE AREA SHALL BE DISTURBED THAN CAN BE STABILIZED BY THE END OF THE WORK DAY. ALL AREAS SHALL BE STABILIZED USING TEMPORARY MULCHING OR GRADED AGGREGATE BASE COURSE BY THE END OF THE WORKDAY AS DIRECTED BY THE ENGINEER.

INNOVATIVE CONTRACTING DIVISION

MARYLAND DEPARTMENT OF TRANSPORTATION STATE HIGHWAY

MD 725 (MAIN STREET) FROM WEST OF SERVICE LANE TO EAST OF GOVERNOR ODEN BOWIE DRIVE SIDEWALKS

	ROADWA	AY PLAN	SHEET	
CALE <u>1" = </u>	15' DATE	APRIL 12, 2022	CONTRACT NO.	PGA115133
ESIGNED BY _	HWP	_ COUNT	Y PRINCE	GEORGE'S
RAWN BY	SAZ	- _ LOGMIL	E	

CHECKED BY _____ REH HORIZONTAL SCALE _ MDE/PRD <u>20-PR-0006-03</u> VERTICAL SCALE _ PS-06 OF 11 SHEET NO. 8 OF 29 DRAWING NO.

Whitman, Requardt & Associates, LLP

MILL & OVERLAY CONCRETE SIDEWALK

<u>LEGEND</u>

CONCRETE, BRICK & GRAVEL REMOVAL (PAID FOR AS CLASS 2 EXCAVATION) 8 INCH PORTLAND
CEMENT CONCRETE DRIVEWAY

NEW CURB

---- APPROX. RIGHT OF WAY & PARCEL LINE

APPROX. 100-YEAR FLOODPLAIN

PLOTTED: December 17, 2021
FILE: N:\31933-017\CADD\Task 1_WRA_PG_MD 725 from Brown Station Road to MD 202\pHD-P006_MD725.dgn

ADMINISTRATION

<u>NOTES</u>

1. CONTRACTOR TO INSTALL CURB FLUSH WITH THE EXISTING


ENSURE POSITIVE DRAINAGE.


ROADWAY AND SIDEWALK AT A 50:1 MAX. CROSS SLOPE TO

2. FROM STA. 19+50, LT. TO STA. 22+64, LT., CONTRACTOR SHALL SAW CUT ALONG THE BACK OF EX. CURB. REMOVE EX. CONCRETE SIDEWALK AND PRESERVE THE EX. CURB. INSTALL


NEW CONCRETE SIDEWALK AT 50:1 MAX CROSS SLOPE USING


THE EX. CURB UNLESS OTHERWISE NOTED ON THE PLANS.

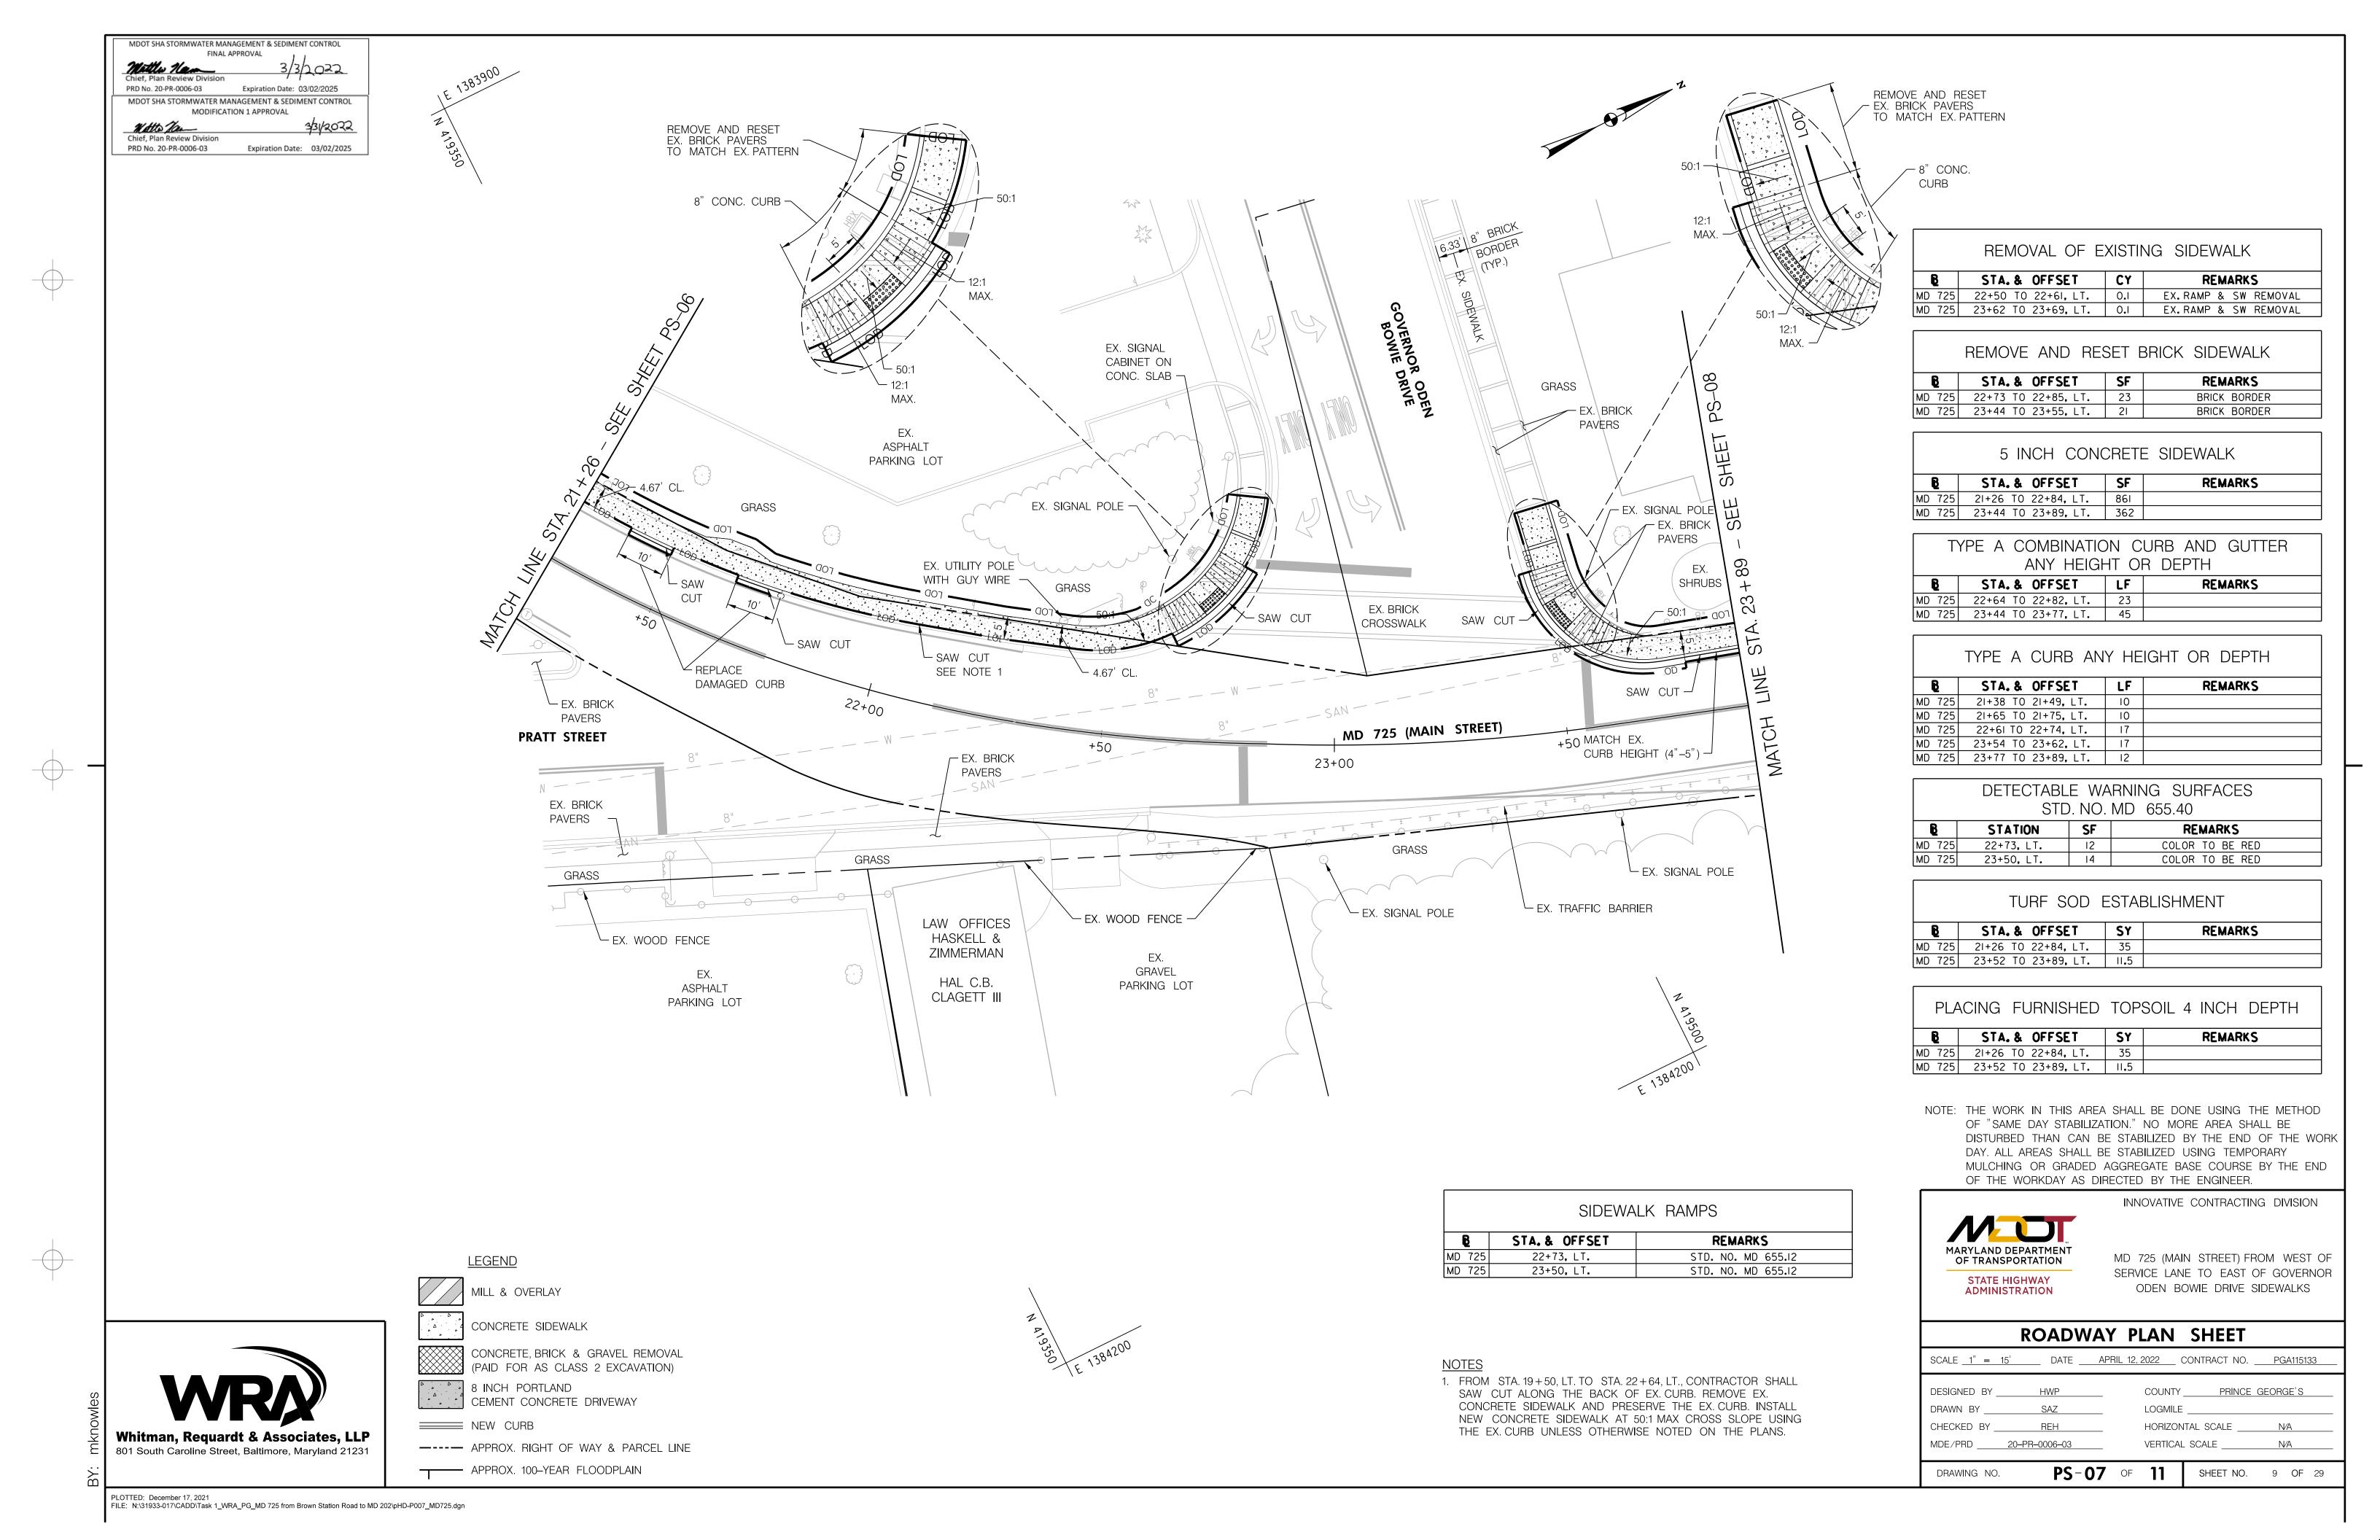

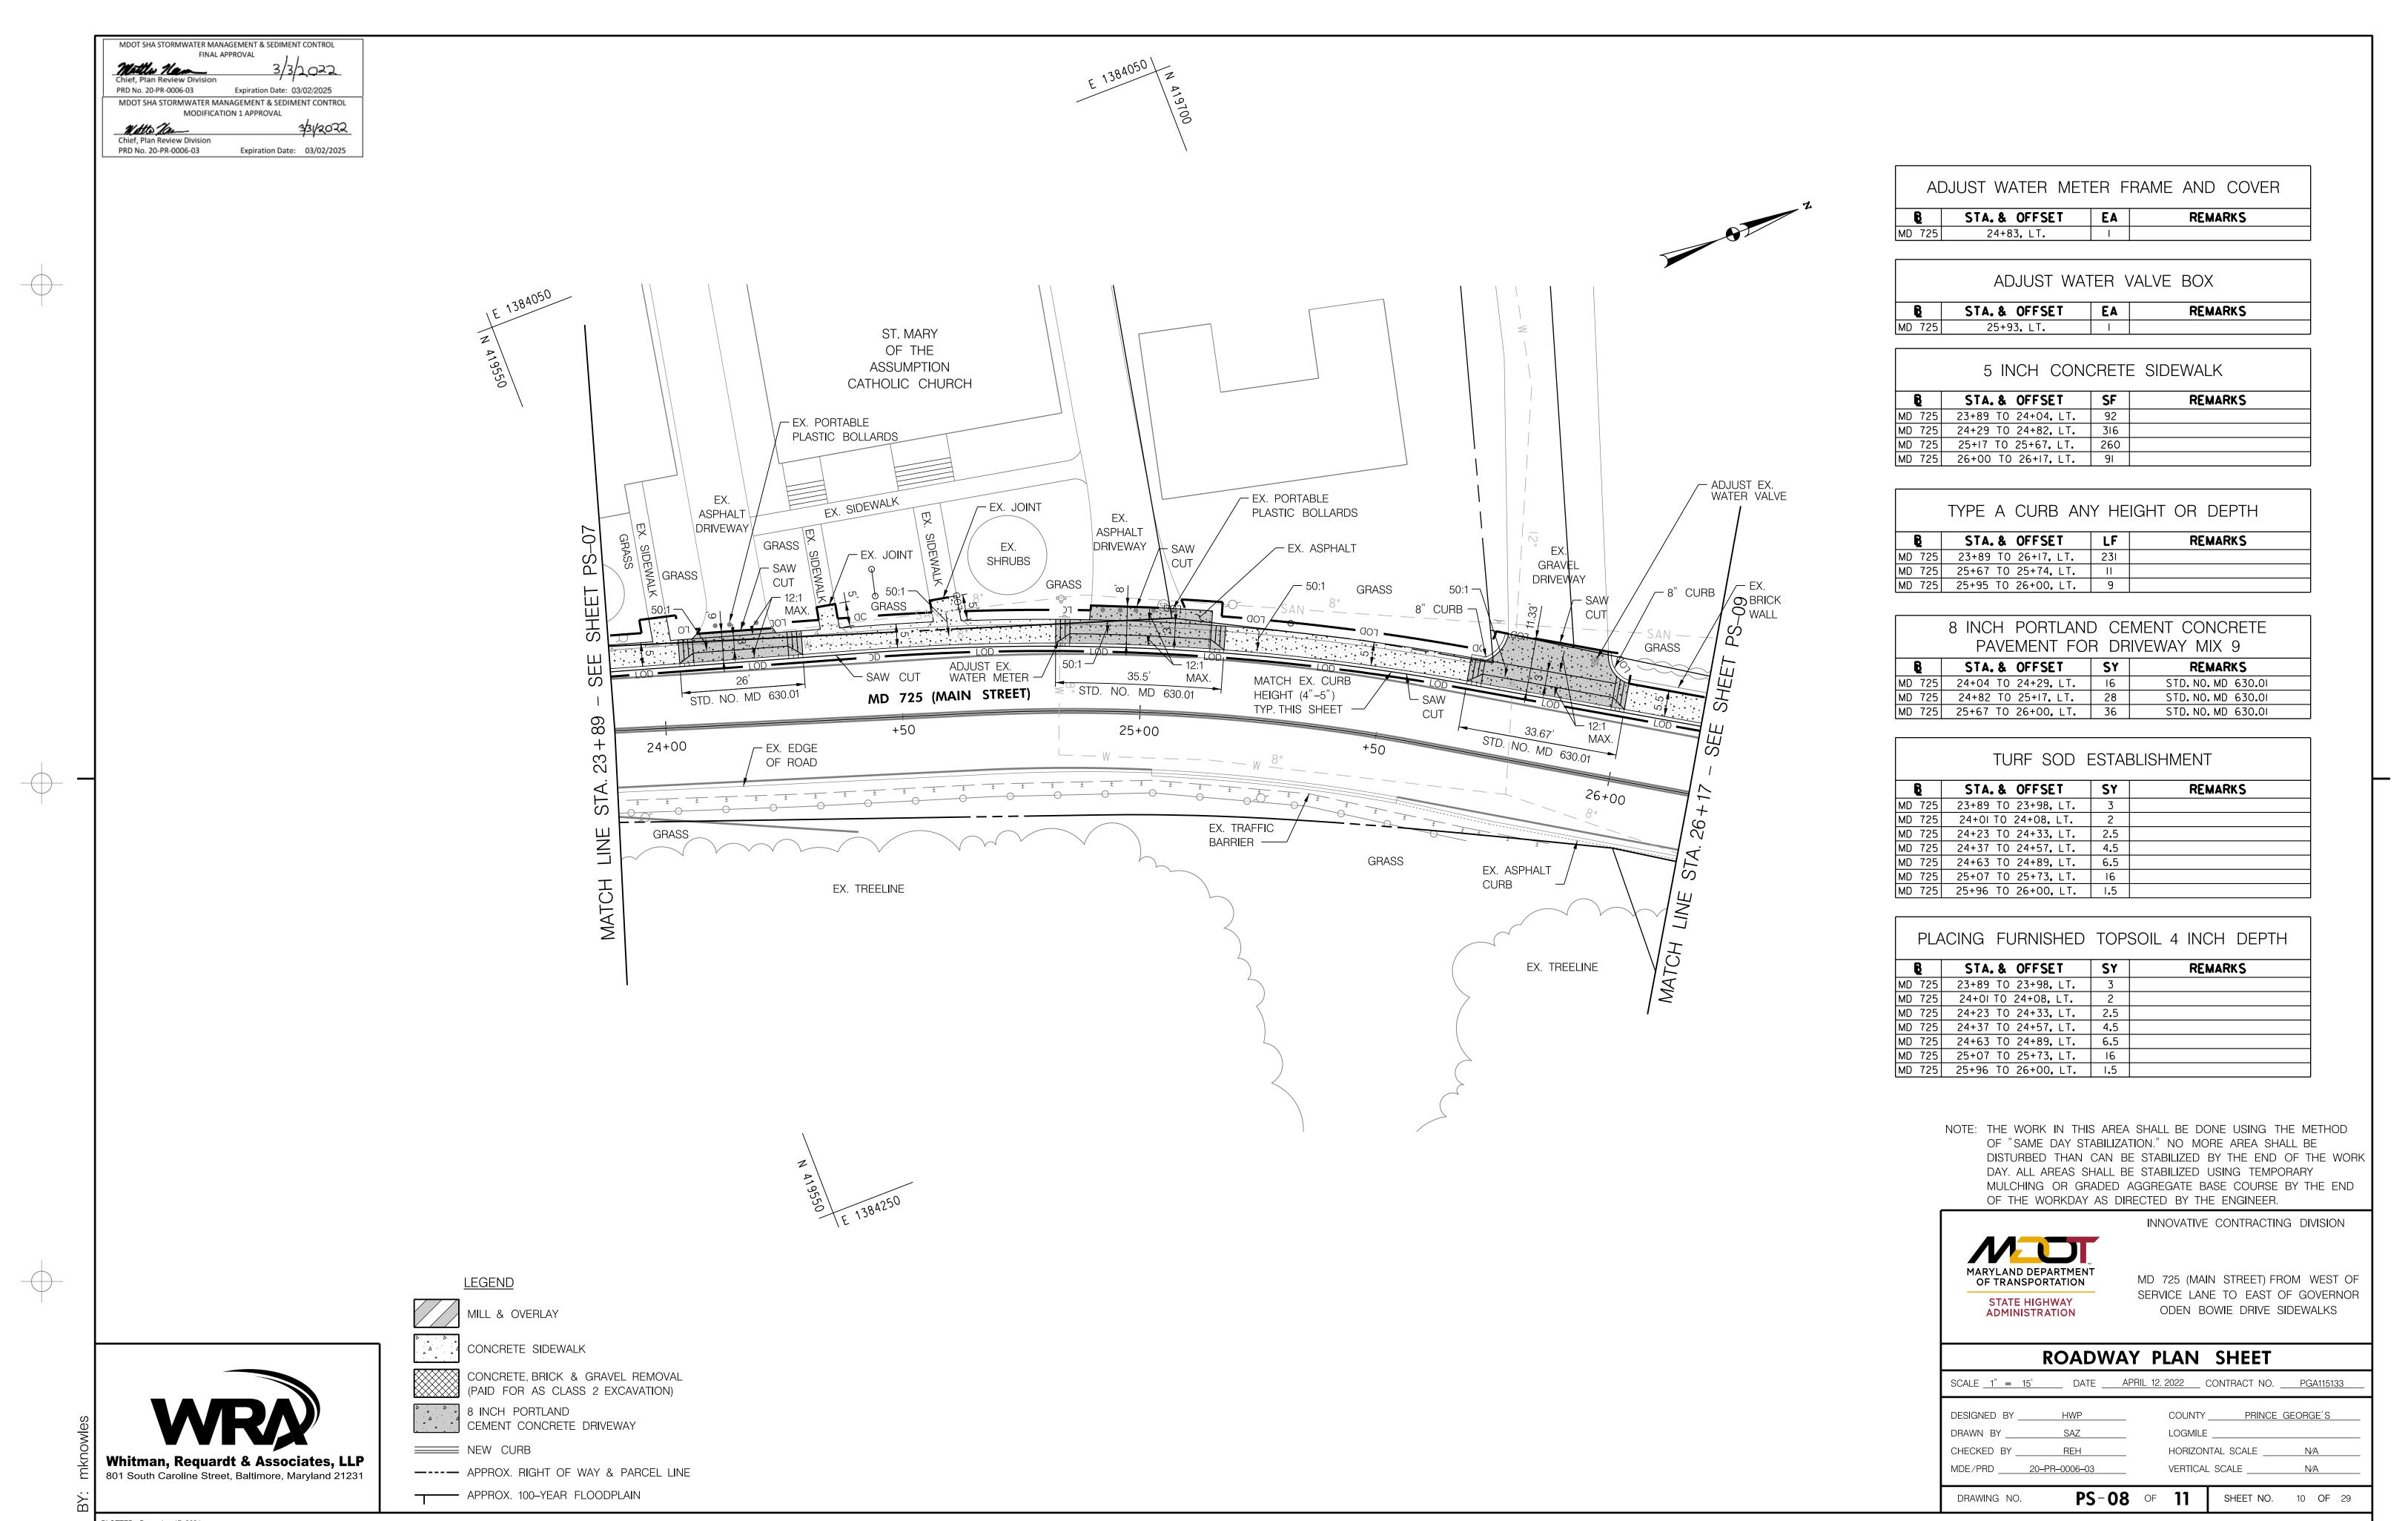


PLOTTED: December 17, 2021
FILE: N:\31933-017\CADD\Task 1_WRA_PG_MD 725 from Brown Station Road to MD 202\pHD-P008_MD725.dgn

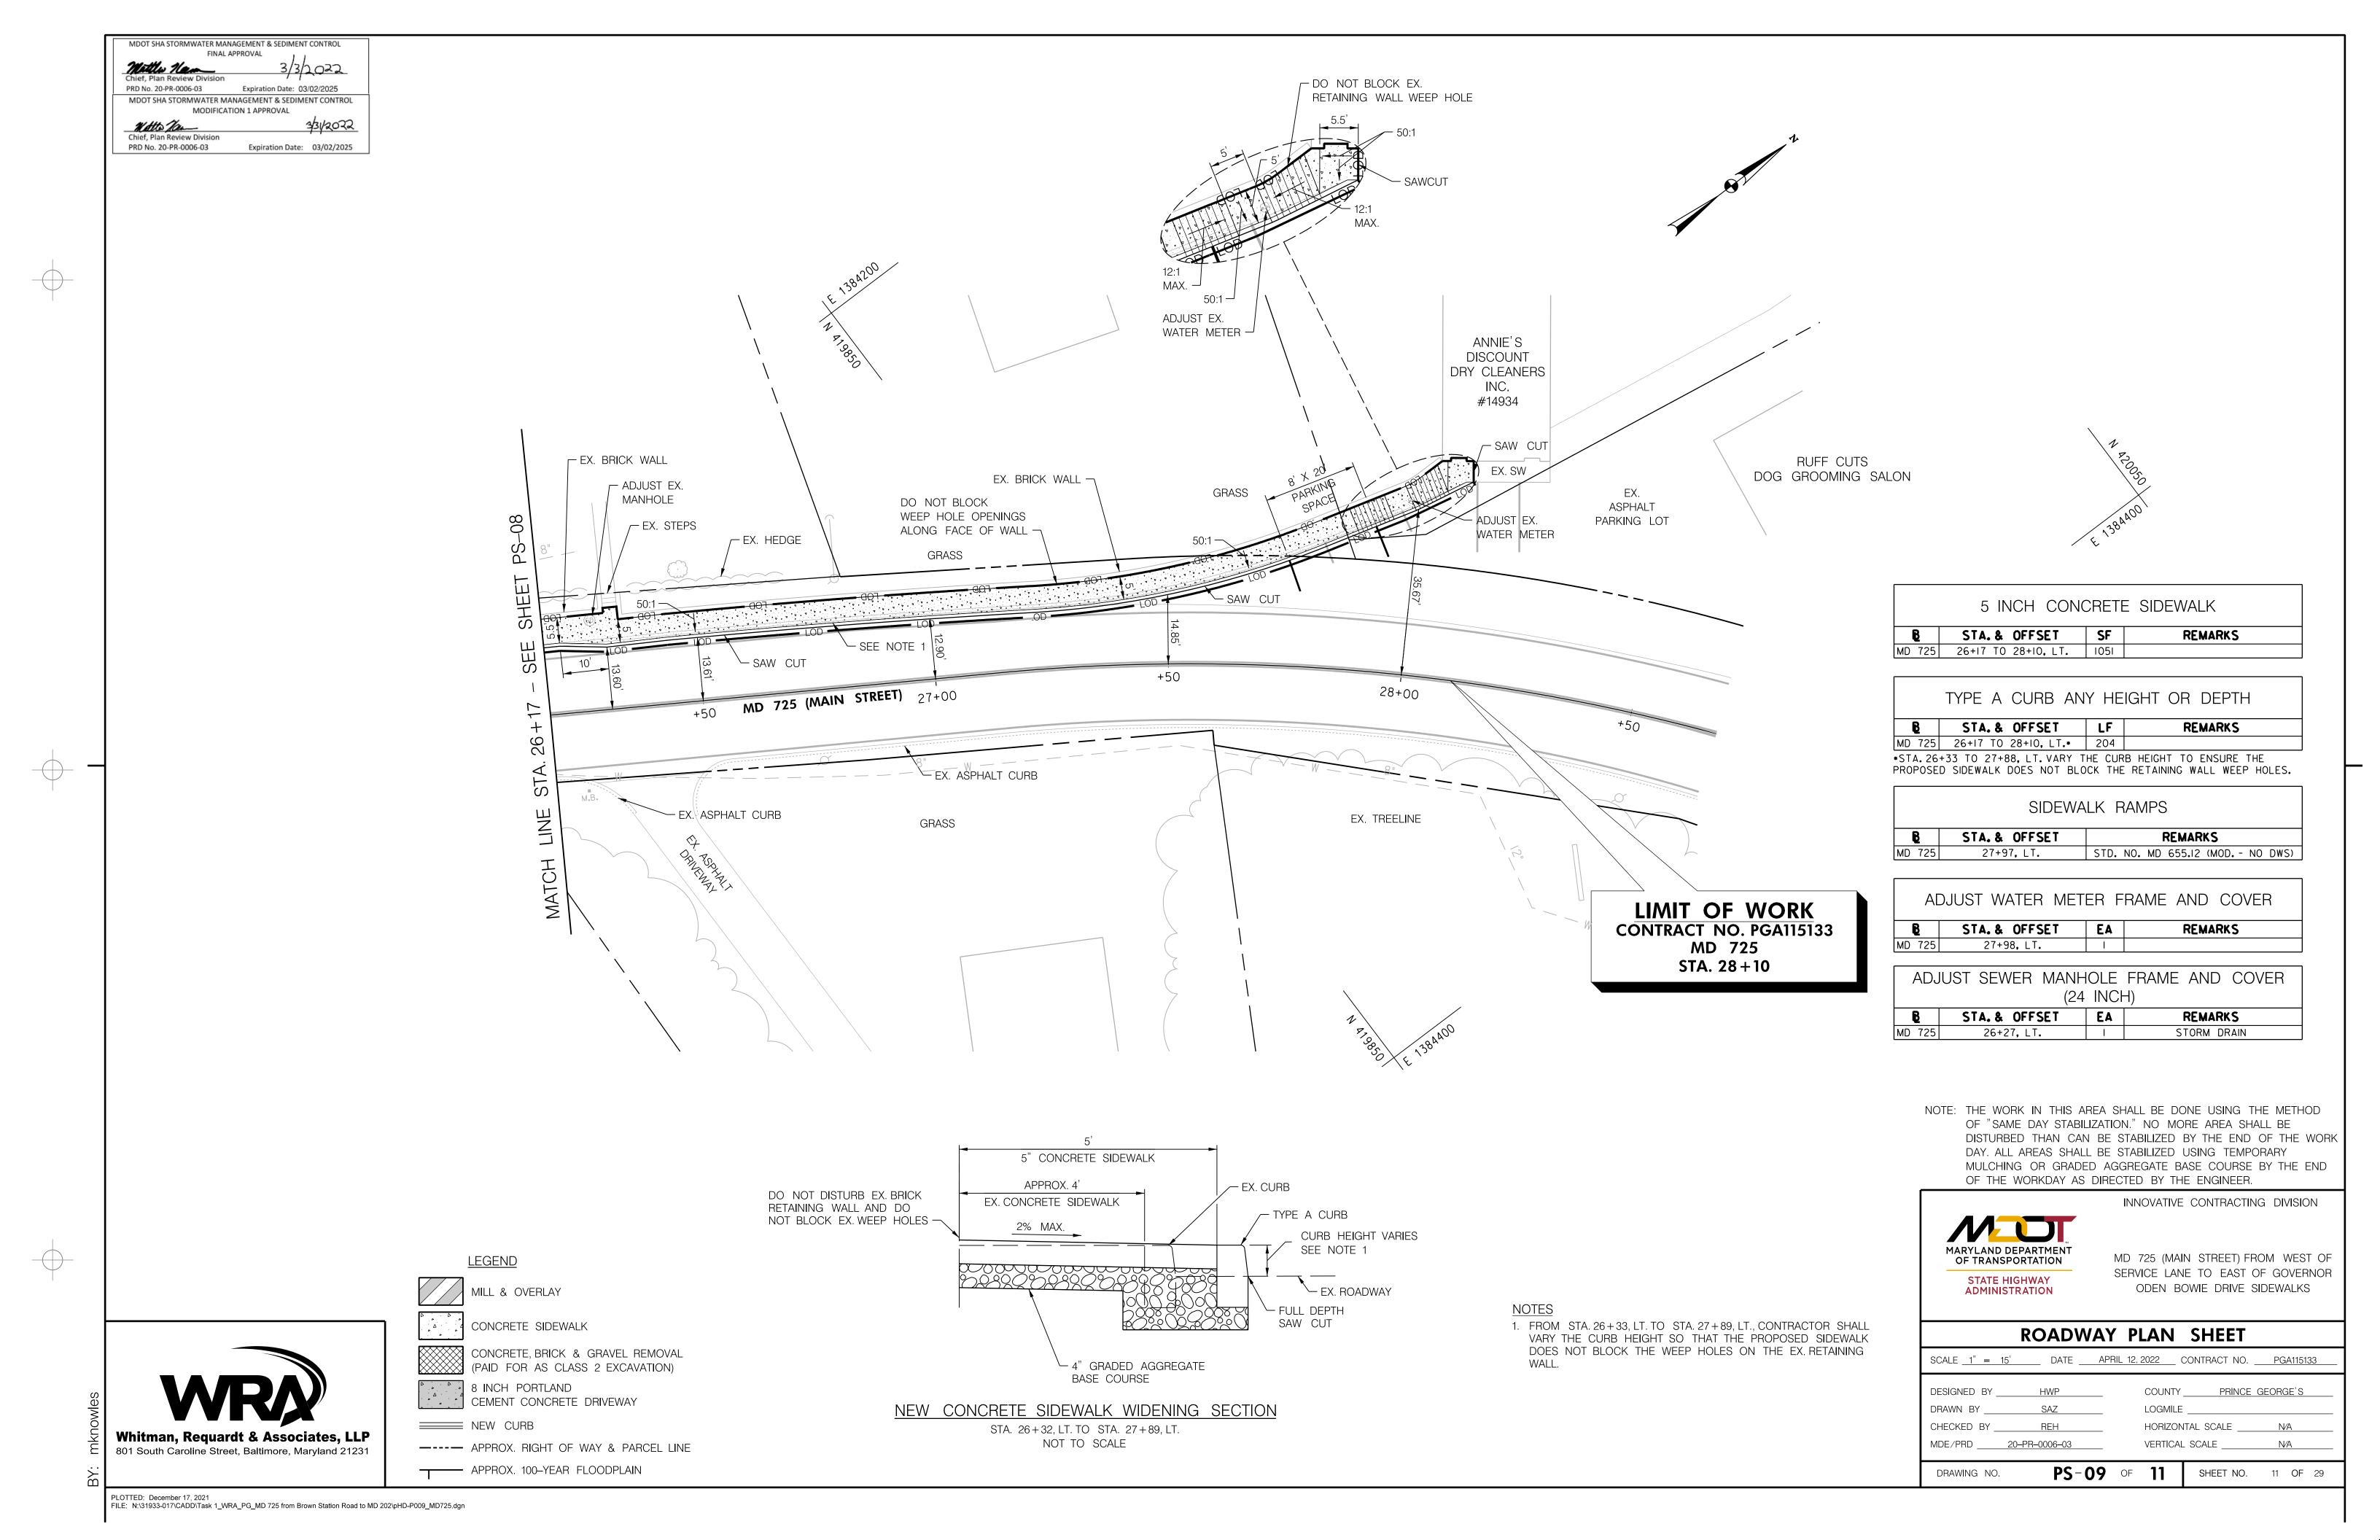

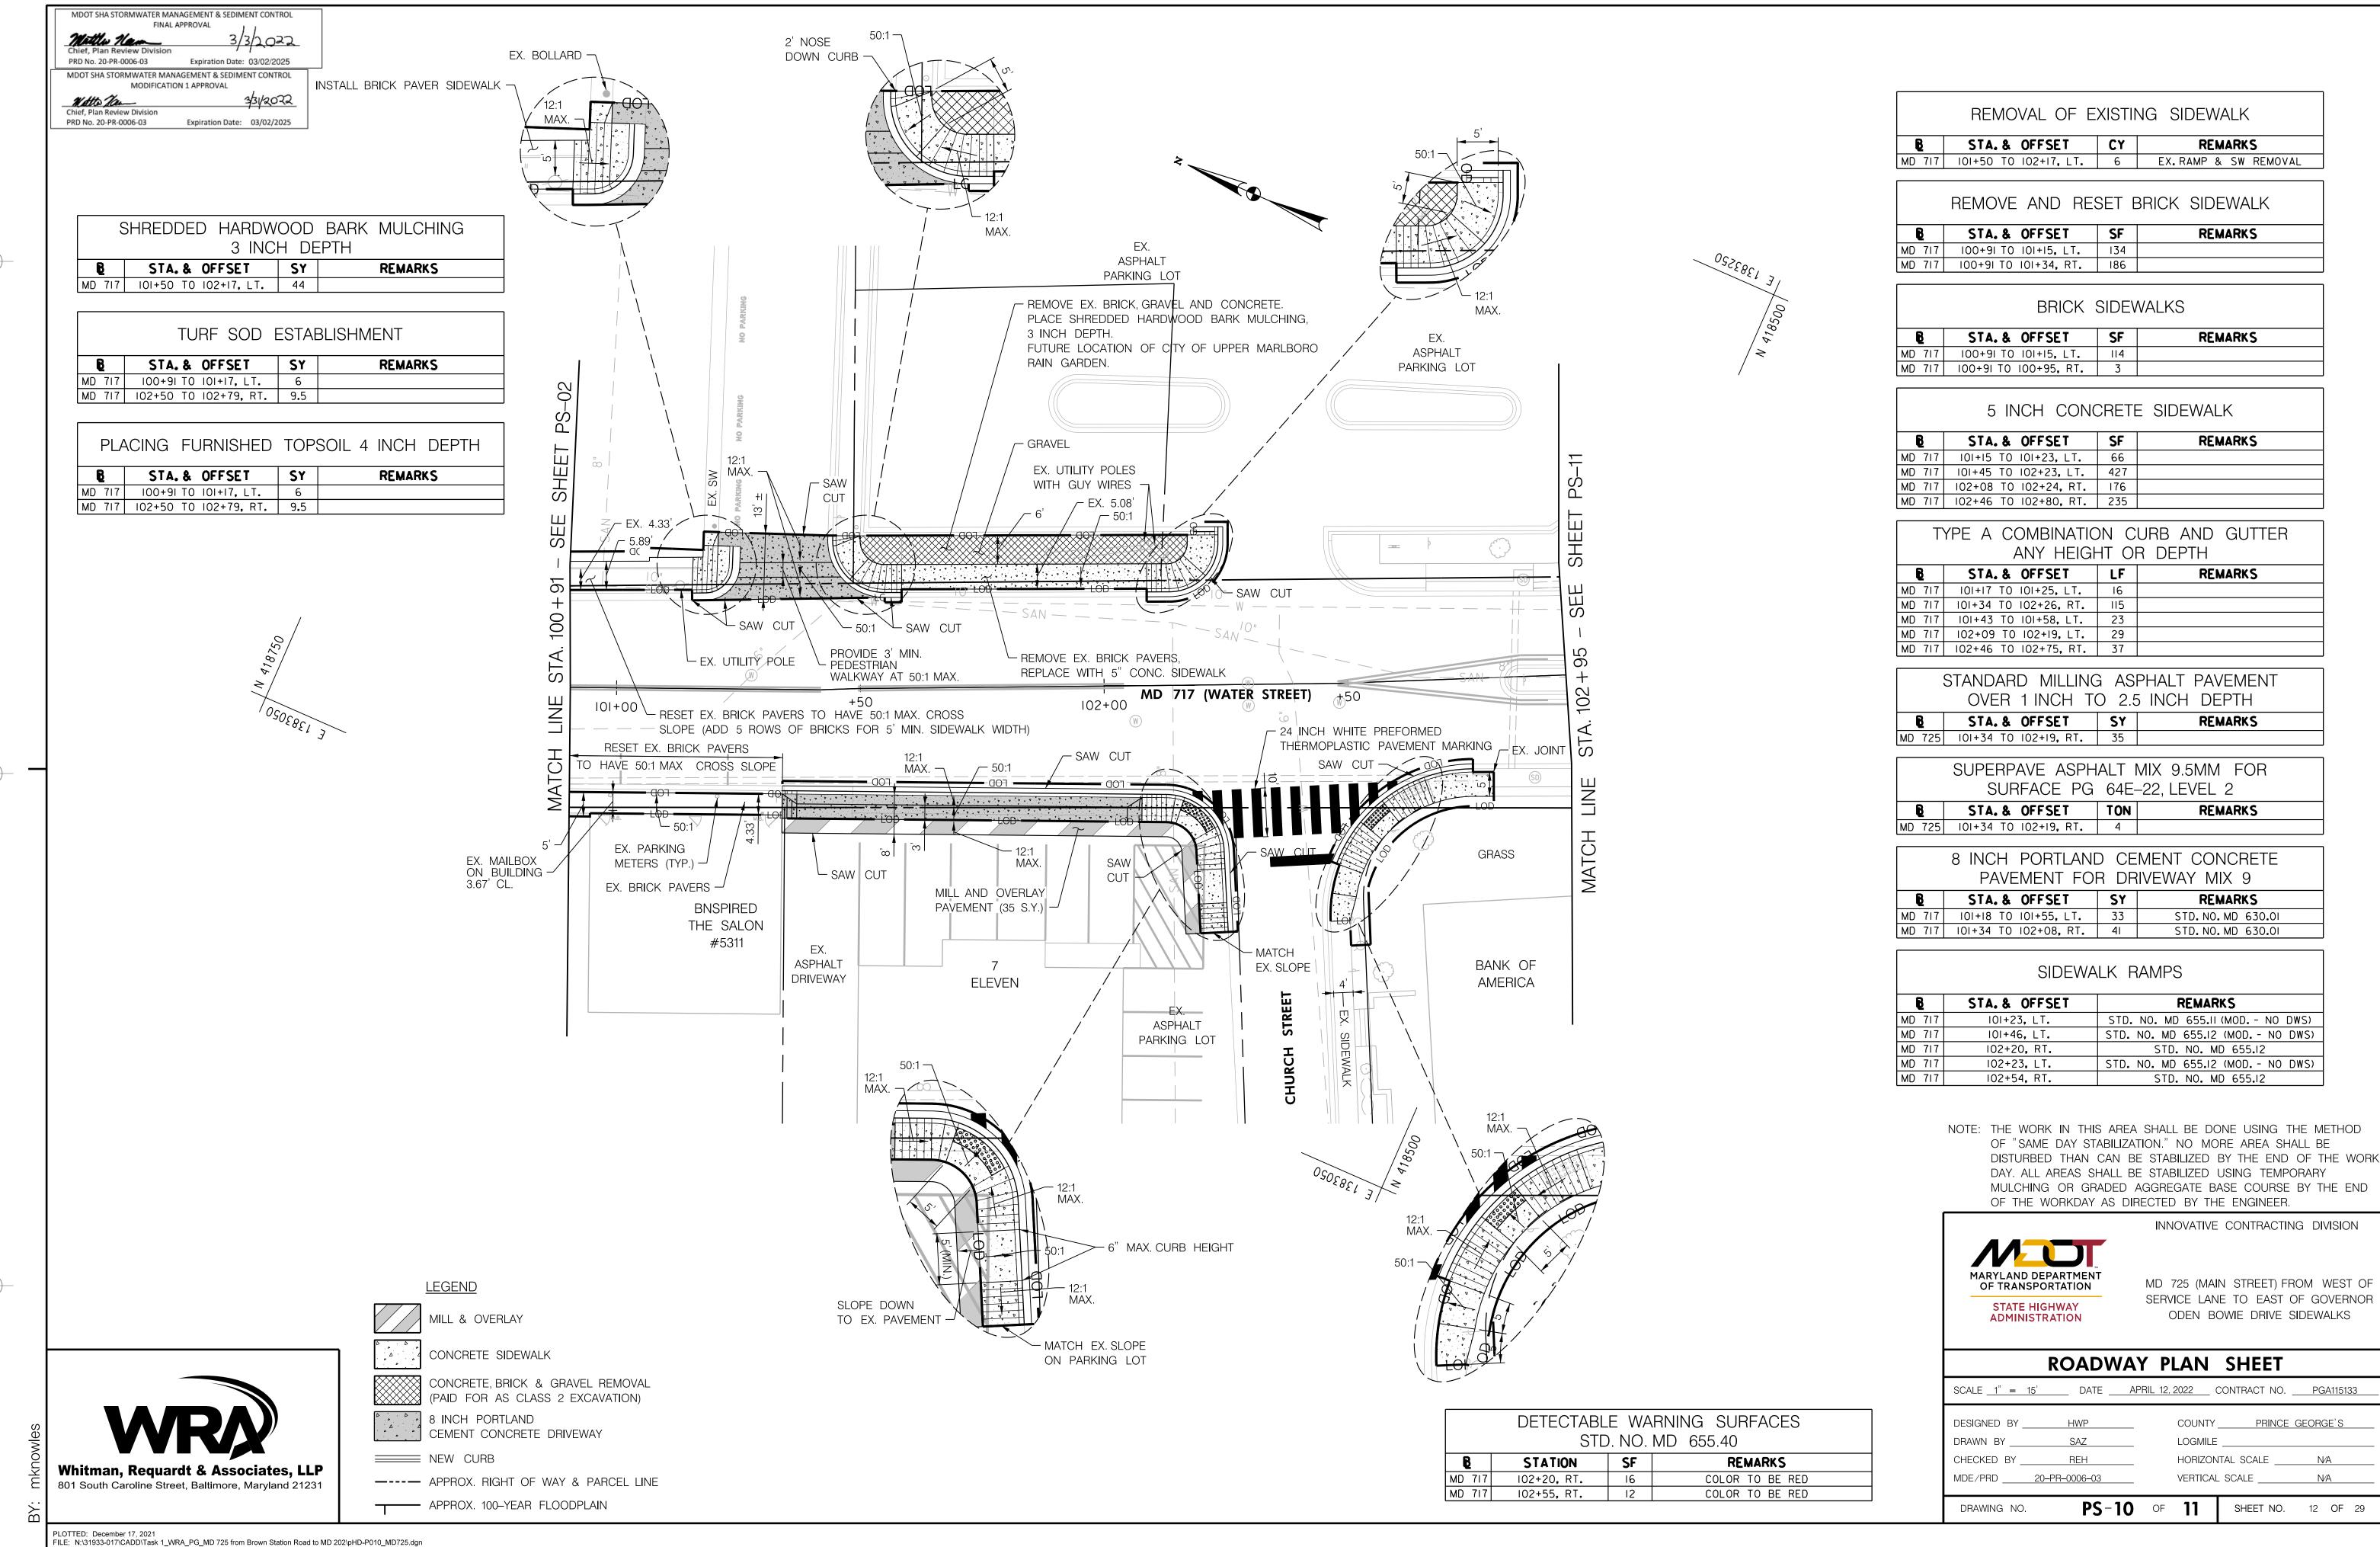

FILE: N:\31933-017\CADD\Task 1_WRA_PG_MD 725 from Brown Station Road to MD 202\pHD-P010_MD725.dgn

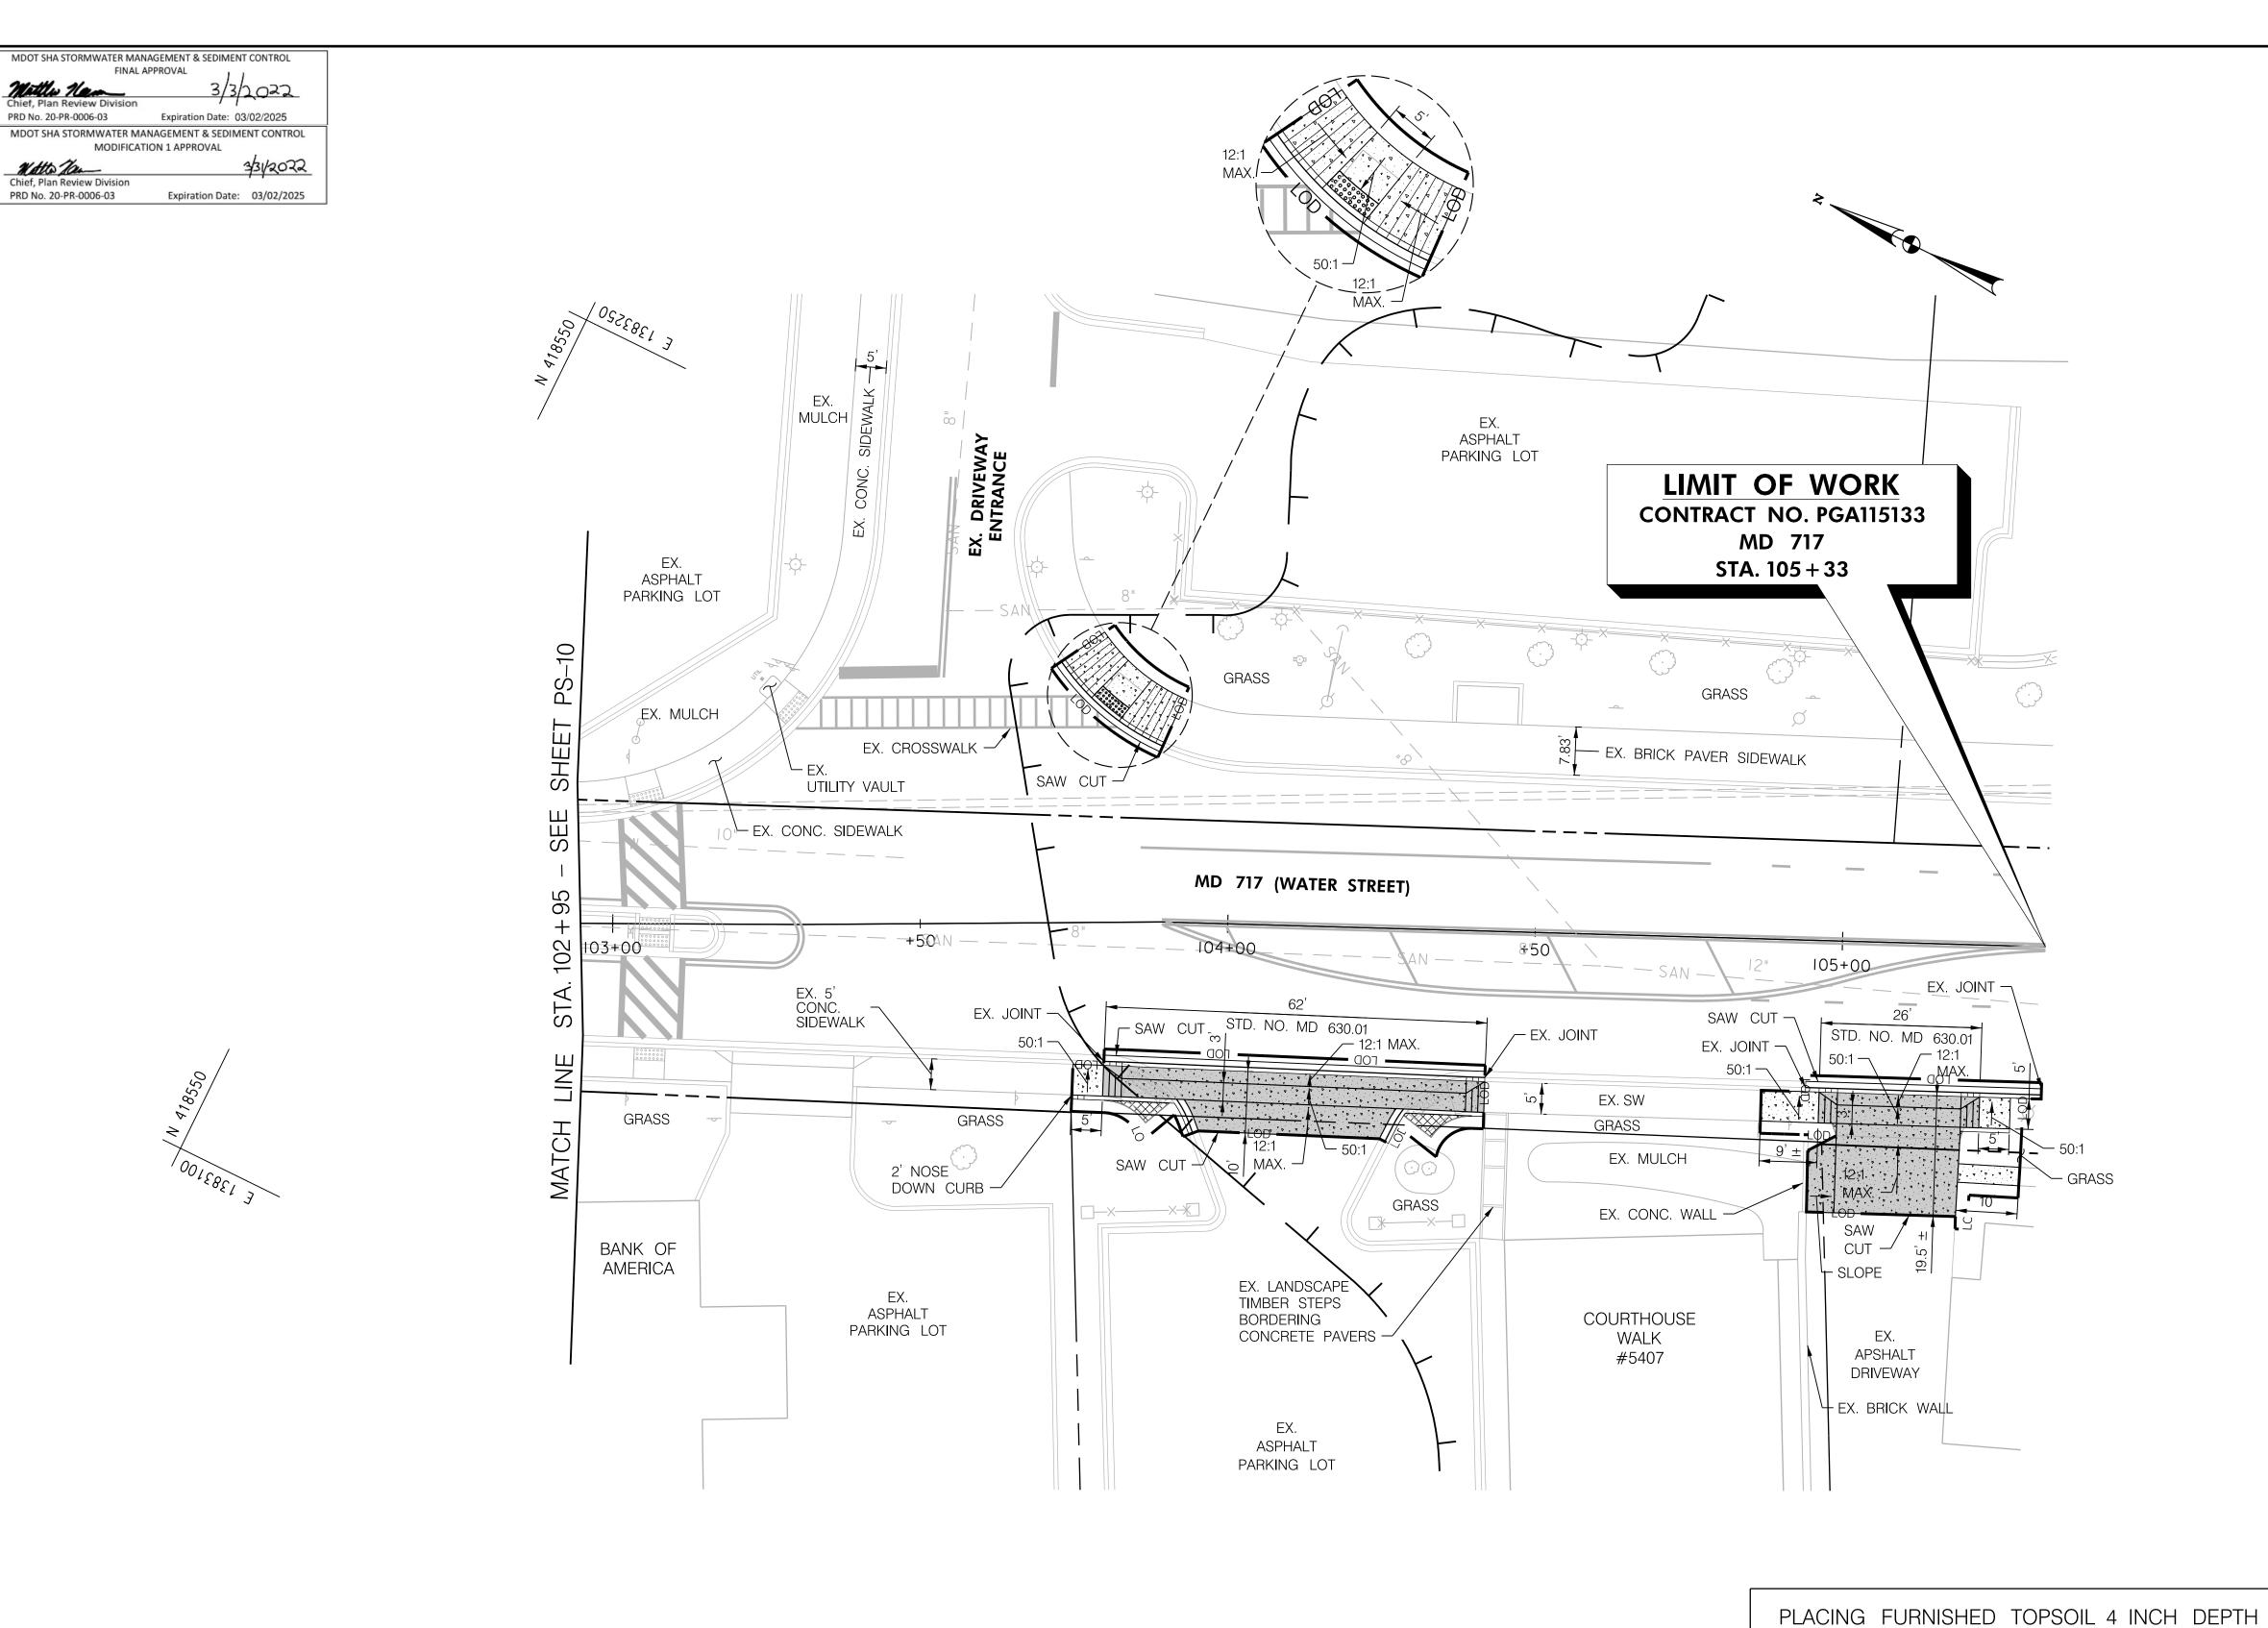

TURF SOD ESTABLISHMENT					
B	STA. & OFFSET	SY	REMARKS		
MD 717	103+80 TO 103+94, LT.	4			
MD 717	103+74 TO 103+93, RT.	5			
MD 717	104+27 TO 104+42, RT.	5			
MD 717	104+87 TO 105+00, RT.	3			
MD 717	105+20 TO 105+30, RT.	3 . 5			
MD 717	105+20 TO 105+30, RT.	7.5			

	REMOVAL OF EXISTING SIDEWALK					
B	STA.& OFFSET	CY	REMARKS			
MD 717	103+80 TO 103+90, RT.	0.25	EX.RAMP & SW REMOVAL			
MD 717	104+29 TO 104+40, RT.	0.25	EX.RAMP & SW REMOVAL			
MD 717	104+99 TO 105+21, RT.	0.1	EX.RAMP & SW REMOVAL			

5 INCH CONCRETE SIDEWALK					
B	STA. & OFFSET	SF	REMARKS		
MD 717	103+74 TO 103+80, RT.	25			
MD 717	103+74 TO 103+93, LT.	150			
MD 717	104+87 TO 104+97, RT.	47			
MD 717	105+20 TO 105+30, RT.	30			
MD 717	105+23 TO 105+28, RT.	25			

TYPE A COMBINATION CURB AND GUTTER ANY HEIGHT OR DEPTH					
B	STA. & OFFSET	LF	REMARKS		
MD 717	103+72 TO 103+90, LT.	22			
MD 717	103+80 TO 104+42, RT.	62			
MD 717	103+92 TO 103+96, RT.	6			
MD 717	104+26 TO 104+30, RT.	6			
MD 717	104+95 TO 105+33, RT.	38			

TYPE A CURB ANY HEIGHT OR DEPTH						
B	STA. & OFFSET	LF	REMARKS			
MD 717	103+74 TO 103+91, RT.	16				
MD 717	104+30 TO 104+42, RT.	13				
MD 717	105+20 TO 105+28, RT.	8				

SIDEWALK RAMPS				
B	STA. & OFFSET	REMARKS		
MD 717	103+81 , LT.	STD. NO. MD 655.12		

	8 INCH PORTLAND CEMENT CONCRETE PAVEMENT FOR DRIVEWAY MIX 9					
B	STA. & OFFSET	SY	REMARKS			
MD 717	103+80 TO 104+42, RT.	52	STD. NO. MD 630.01			
MD 717	104+97 TO 105+23, RT.	52	STD. NO. MD 630.01			

	DETECTABLE WARNING SURFACES					
	STD. NO. MD 655.40					
B	STATION	SF	REMARKS			
MD 717	103+81, LT.	12	COLOR TO BE RED			

NOTE: THE WORK IN THIS AREA SHALL BE DONE USING THE METHOD OF "SAME DAY STABILIZATION." NO MORE AREA SHALL BE DISTURBED THAN CAN BE STABILIZED BY THE END OF THE WORK DAY. ALL AREAS SHALL BE STABILIZED USING TEMPORARY MULCHING OR GRADED AGGREGATE BASE COURSE BY THE END OF THE WORKDAY AS DIRECTED BY THE ENGINEER.

INNOVATIVE CONTRACTING DIVISION



MD 725 (MAIN STREET) FROM WEST OF SERVICE LANE TO EAST OF GOVERNOR ODEN BOWIE DRIVE SIDEWALKS

SHEET NO. 13 OF 29

	ROADWA	AY PLAN SHEET
SCALE <u>1" = 15</u>	<u> </u>	APRIL 12, 2022 CONTRACT NO. PGA115133
DESIGNED BY	HWP SAZ	
CHECKED BY		HORIZONTAL SCALE N/A

PS-11 OF 11

Whitman, Requardt & Associates, LLP

MILL & OVERLAY CONCRETE SIDEWALK CONCRETE, BRICK & GRAVEL REMOVAL (PAID FOR AS CLASS 2 EXCAVATION) 8 INCH PORTLAND
CEMENT CONCRETE DRIVEWAY NEW CURB

---- APPROX. RIGHT OF WAY & PARCEL LINE

APPROX. 100-YEAR FLOODPLAIN

<u>LEGEND</u>

B STA. & OFFSET SY

MD 717 103+80 TO 103+94, LT. 4

MD 717 103+74 TO 103+93, RT. 5

MD 717 | 104+27 TO 104+42, RT. | 5 MD 717 | 104+87 TO 105+00, RT. | 3 MD 717 105+20 TO 105+30, RT. 3.5

MD 717 105+20 TO 105+30, RT. 7.5

REMARKS

PLOTTED: December 17, 2021
FILE: N:\31933-017\CADD\Task 1_WRA_PG_MD 725 from Brown Station Road to MD 202\pHD-P011_MD725.dgn

EROSION AND SEDIMENT CONTROL - GENERAL NOTES

1. NOTIFICATION

NOTIFY THE REGIONAL ENVIRONMENTAL COORDINATOR (REC) IN WRITING AND/OR BY TELEPHONE AT (410) 365-0164 PRIOR TO THE FOLLOWING POINTS:

- PRE-CONSTRUCTION MEETING.
- EROSION AND SEDIMENT CONTROL (ESC) MEETING (MINIMUM 7 WORKING DAYS PRIOR TO COMMENCING EARTH DISTURBING
- UPON INSTALLATION OF INITIAL ESC MEASURES.
- INSTALLATION OF MAJOR ESC BASINS/TRAPS.
- REMOVAL OR MODIFICATION OF ANY ESC MEASURES.
- REMOVAL OF ALL ESC DEVICES.
- FINAL ACCEPTANCE BY THE ADMINISTRATION.

2. STANDARDS AND SPECIFICATIONS

CONSTRUCT THIS PLAN ACCORDING TO THE MARYLAND DEPARTMENT OF THE ENVIRONMENT (MDE) "2011 MARYLAND STANDARDS AND SPECIFICATIONS FOR SOIL EROSION AND SEDIMENT CONTROL", THE MDE "2000 MARYLAND STORMWATER DESIGN MANUAL, VOLUMES I & II", THE MDOT SHA "FIELD GUIDE FOR EROSION AND SEDIMENT CONTROL", THE ANNOTATED CODE OF MARYLAND, THE CODE OF MARYLAND (COMAR) 26.17.01 AND 26.17.02, ALL REVISIONS THERE OF, AND AS SPECIFIED. KEEP A COPY OF THE 2011 "MARYLAND STANDARDS AND SPECIFICATIONS FOR SOIL EROSION AND SEDIMENT CONTROL" ON THE SITE AT ALL TIMES. PERFORM VEGETATIVE STABILIZATION ACCORDING TO THOSE STANDARDS AND AS SPECIFIED.

3. INSPECTION

DAILY INSPECT ALL ESC MEASURES AND MAINTAIN THEM IN A CONTINUOUSLY-EFFECTIVE OPERATING CONDITION UNTIL REMOVED AS APPROVED BY THE REC AND THE ENGINEER.

4. SHUTDOWNS / LIQUIDATED DAMAGES

COMPLETE COMPLIANCE WITH THE APPROVED ESC PLAN IS EXPECTED AT ALL TIMES. IN CASES WHERE THE CONTRACTOR IS FOUND TO BE IN NON-COMPLIANCE, THE ADMINISTRATION WILL TAKE STEPS TO IMPOSE SELECTED OR TOTAL SHUTDOWNS AND MAY IMPOSE LIQUIDATED DAMAGES FOR NON-COMPLIANCE.

THE ADMINISTRATION'S DISTRICT ENGINEER MAY IMPOSE A TOTAL OR PARTIAL SHUTDOWN IF THE PROJECT MAY ADVERSELY IMPACT THE WATERS OF THE STATE.

5. RECORD KEEPING

ENSURE THE STORMWATER MANAGEMENT (SWM)/ESC APPROVAL LETTER, APPROVED EROSION AND SEDIMENT CONTROL PLANS, APPROVED MODIFICATIONS, MODIFICATION APPROVAL LETTER(S), DAILY LOG **BOOKS, TEST REPORTS, AND NATIONAL POLLUTANT DISCHARGE ELIMINATION SYSTEM (NPDES) NOTICE OF INTENT (NOI) PERMIT** ARE AVAILABLE ON-SITE FOR REVIEW AND INSPECTION BY THE ADMINISTRATION.

6. CLEARING AND GRUBBING

UNLESS OTHERWISE SPECIFIED OR APPROVED, LIMIT THE CLEARING AND GRUBBING AREA TO A SINGLE 20-ACRE GRADING UNIT PER GRADING OPERATION. ONCE THIS FIRST UNIT IS HALF GRADED, STABILIZATION MEASURES ARE IN PLACE, AND APPROVED, WORK MAY PROCEED TO A SECOND 20-ACRE GRADING UNIT. UNLESS SPECIFICALLY APPROVED, NO MORE THAN 30 ACRES MAY BE DISTURBED AT ANY TIME.

7. SENSITIVE AREAS

WITH THE APPROVAL AND ASSISTANCE OF THE ENGINEER, COORDINATE WITH THE APPROPRIATE ADMINISTRATION REPRESENTATIVES TO COORDINATE WITH THE APPROPRIATE REGULATORY AGENCIES TO ENSURE THAT ALL PERMIT CONDITIONS ARE MET PRIOR TO COMMENCING CONSTRUCTION ACTIVITIES WITHIN SPECIFIED SENSITIVE AREAS. SENSITIVE AREAS INCLUDE BUT ARE NOT LIMITED TO FLOODPLAINS, WETLANDS, WETLAND BUFFERS, CHESAPEAKE BAY CRITICAL AREA, FORESTS, ARCHEOLOGICAL SITES, HISTORIC SITES, PARKLAND, AND OPEN WATERS. DESIGNATE A RESPONSIBLE PARTY TO MONITOR ALL WORK IN THESE AREAS AND ENSURE THAT REASONABLE CARE IS TAKEN DURING WORK IN AND ADJACENT TO THESE AREAS.

8. INGRESS / EGRESS CONTROLS

PROTECT ALL POINTS OF CONSTRUCTION INGRESS AND EGRESS AND PREVENT THE DEPOSITION OF MATERIALS ON PUBLIC ROADS. IF DEPOSITION OCCURS, MECHANICALLY REMOVE ALL MATERIALS DEPOSITED ON PUBLIC ROADS IMMEDIATELY. FLUSHING OF ROAD SURFACES IS PROHIBITED. WHEN NO SCE IS PROVIDED, KEEP ALL CONSTRUCTION EQUIPMENT WITHIN THE LOD UNTIL THE WORK IS COMPLETE. CLEAN TREADS/TIRES PRIOR TO THE EQUIPMENT LEAVING THE LOD.

9. EROSION AND SEDIMENT CONTROL EXCAVATION

DISPOSE OF MATERIAL REMOVED FROM ESC DEVICES IN AN APPROVED WASTE SITE AS SPECIFIED IN SECTION 201. MATERIALS MAY BE STORED FOR RE-USE. MATERIALS STORED ON-SITE MAY BE REUSED ONCE IT IS DRIED AND IF IT MEETS THE REQUIREMENTS FOR **EMBANKMENTS OR OTHER UNSPECIFIED NEEDS.**

10. DEWATERING PRACTICES

OPERATE DEWATERING PRACTICES IN A MANNER THAT DOES NOT DISCHARGE SEDIMENT INTO WATERWAYS. NO VISIBLE CHANGES TO STREAM CLARITY ARE ACCEPTABLE.

11. STANDARD STABILIZATION NOTE

FOLLOWING INITIAL SOIL DISTURBANCE OR REDISTURBANCE, COMPLETE PERMANENT OR TEMPORARY STABILIZATION WITHIN THREE (3) CALENDAR DAYS FOR SURFACES OF ALL PERIMETER CONTROLS, DIKES. SWALES, DITCHES, PERIMETER SLOPES, AND ALL SLOPES GREATER THAN 3 HORIZONTAL TO 1 VERTICAL (3:1); AND SEVEN (7) DAYS AS TO ALL OTHER DISTURBED OR GRADED AREAS ON THE SITE. ENSURE CONTINUED STABILIZATION.

12. INCREMENTAL STABILIZATION

REFER TO THE MDE "2011 MARYLAND STANDARDS AND SPECIFICATIONS FOR SOIL EROSION AND SEDIMENT CONTROL" FOR THE INCREMENTAL STABILIZATION OF CUT AND FILLS.

13. SEDIMENT TRAPS AND BASINS

PLAN DIMENSIONS ARE RELATIVE TO THE OUTLET ELEVATION. MAINTAIN INFLOW AND OUTFLOW LOCATIONS FOR TRAPS AND BASINS IN STABLE CONDITION.

14. OFF-SITE UTILITY WORK

FOLLOW ADDITIONAL BEST MANAGEMENT ESC PRACTICES FOR UTILITY CONSTRUCTION IN AREAS OUTSIDE OF DESIGNED CONTROLS:

- (a) CALL "MISS UTILITY" AT 1-800-257-7777 AT LEAST 48 HOURS
- PRIOR TO THE START OF WORK. (b) PLACE EXCAVATED MATERIAL ON THE HIGH SIDE OF TRENCHES.
- (c) BACKFILL, COMPACT, AND STABILIZE AT THE END OF EACH WORKING DAY ALL TRENCHES FOR UTILITY INSTALLATIONS. WHEN THIS IS NOT POSSIBLE, CONFORM TO (d).
- (d) PLACE TEMPORARY SILT FENCES IMMEDIATELY DOWNSTREAM OF ANY DISTURBED AREA THAT IS INTENDED TO REMAIN DISTURBED FOR MORE THAN ONE (1) DAY.

15. SITE INFORMATION*


_			
Α.	TOTAL AREA DISTURBED _	0.54	ACRES
В.	TOTAL CUT _	3	CU. YDS
C.	TOTAL FILL _	0	CU. YDS
D.	OFFSITE WASTE/BORROW		
	AREA LOCATION (IF KNOWN)	N/A	

^{* (}NOT FOR BIDDING PURPOSES)

16. MODIFICATIONS

SUBMIT MODIFICATIONS OF THE ESC MEASURES OR PLAN TO THE ADMINISTRATION FOR APPROVAL. OBTAIN ALL APPROVALS PRIOR TO **IMPLEMENTING ANY MODIFICATION.**

		STANDARD SYMBO	LS		
100-YEAR FLOODPLAIN		MEDIAN INLET PROTECTION	MIP	STONE CHECK DAM	CD
AT-GRADE INLET PROTECTION	AGIP	MEDIAN SUMP INLET PROTECTION	MSIP	STONE/RIPRAP OUTLET SEDIMENT TRAP ST II	ST-II
BAFFLE BOARDS		MOUNTABLE BERM	MB	SUBSURFACE DRAINS	├─ SSD ── -
BENCHING	BENCHING	PERIMETER DIKE/SWALE	₽DS-I ₩ ₩ ₩	SUMP PIT	⊠SP
CATCH BASIN INSERT	[]сві	PERMANENT SOIL STABILIZATION MATTING-TYPE B	BBBB	SUPER SILT FENCE	⊢—SSF——I
CHESAPEAKE BAY CRITICAL AREA	CBCA ——— (PERMANENT SOIL STABILIZATION MATTING-TYPE C		TEMPORARY ACCESS BRIDGE	ТВ
CLEAR WATER DIVERSION PIPE NOTE: DESIGNATION CWD-12 REFERS TO CLEAR WATER DIVERSION WITH 12 INCH PIPE.	CWD - 12	PIPE OUTLET SEDIMENT TRAP ST I	ST-I	TEMPORARY ACCESS CULVERT	
CLEAR WATER PIPE	⊢—— CWP	PIPE SLOPE DRAIN NOTE: DESIGNATION PSD-12 REFERS TO PIPE SLOPE DRAIN WITH 12 IN PIPE	PSD - 12	TEMPORARY ASPHALT BERM	T <u>AB</u>
COMBINATION INLET PROTECTION	COIP	PLUNGE POOL	РР	TEMPORARY BARRIER DIVERSION	TBD
CONCRETE WASHOUT STRUCTURE	CWS	PORTABLE SEDIMENT TANK	⊠PST	TEMPORARY GABION OUTLET STRUCTURE	TGOS
CURB INLET PROTECTION	[4] CIP	PROPOSED CONTOURS	 100 	TEMPORARY ORANGE CONSTRUCTION FENCE (TOCF)	TOCF
DIVERSION FENCE	├── DF ───	REMOVABLE PUMPING STATION	⊠RPS	TEMPORARY SOIL STABILIZATION MATTING-TYPE A	
DRAINAGE BOUNDARY	DA	RIPRAP INFLOW PROTECTION	Ø RRP S	TEMPORARY SOIL STABILIZATION MATTING-TYPE E	
NOTE: PLACE DESIGNATION (A-1, B-2, ETC.) ON FLOW CHANNEL SIDE OF DIKE.	▲ -I	RIPRAP OUTLET SEDIMENT TRAP ST III	ST-III	TEMPORARY SOIL STABILIZATION MATTING-TYPE D	
EMERGENCY SPILLWAY	ES	ROCK OUTLET PROTECTION I	ROPI	TEMPORARY STONE OUTLET STRUCTURE	₹ ₹
EXISTING CONTOURS	<u> </u>	ROCK OUTLET PROTECTION II	ROPII	TEMPORARY SWALE NOTE: PLACE DESIGNATION (A-1, B-2, ETC.) ON FLOW CHANNEL SIDE OF SWALE.	▲ A-I =
FILTER BAG	⊠FB	ROCK OUTLET PROTECTION III	ROPIII	TREE PROTECTION FENCE	TPF
FILTER BERM	FB-A FB-B	SILT FENCE	├──SF──I	VERTICAL DRAW-DOWN DEVICE	VDDD
NOTE: DESIGNATION FL-18 FILTER LOG REFERS TO FILTER LOG WITH 18 INCH DIAMETER.	FL-18	SILT FENCE ON PAVEMENT	SF0P	WASH RACK OPTION	[WR]
GABION INFLOW PROTECTION	GP □	SOD	* * * * * * * * * * * * * * * * * * * *	WETLAND	• • • • •
GABION INLET PROTECTION	[]GIP	STABILIZED CONSTRUCTION ENTRANCE (SCE)	SCE SCE	WETLAND BUFFER	— в —
HORIZONTAL DRAW-DOWN DEVICE	HDDD	STANDARD INLET PROTECTION	[] SIP		
LIMIT OF DISTURBANCE	——LOD——	STOCKPILE AREA			

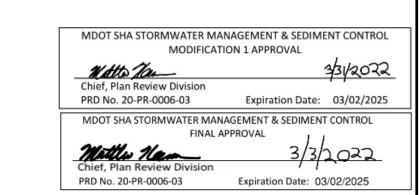



MDE/PRD

DRAWING NO.

INNOVATIVE CONTRACTING DIVISION ADA SIDEWALK UPGRADES

VERTICAL SCALE ___

MD 725 (MAIN STREET) FROM WEST OF SERVICE LANE TO EAST OF GOVERNOR ODEN BOWIE DRIVE

SHEET NO. 14 OF 29



P.E. CERTIFICATION I HEREBY CERTIFY THAT THESE DOCUMENTS WERE PREPARED OR APPROVED BY ME, AND THAT I AM A DULY LICENSED PROFESSIONAL ENGINEER UNDER

LICENSE NO. 22051 EXPIRATION DATE: 07/25/2022

THE LAWS OF THE STATE OF MARYLAND

DESIGN CERTIFICATION I HEREBY CERTIFY THAT THIS PLAN HAS BEEN DESIGNED IN ACCORDANCE WITH THE MARYLAND STANDARDS AND SPECIFICATIONS FOR SOIL EROSION AND SEDIMENT CONTROL, THE 2000 MARYLAND STORMWATER DESIGN MANUAL, VOLUMES 1 & II INCLUDING SUPPLEMENTS, THE ENVIRONMENT ARTICLE SECTIONS 4-101 THROUGH 116 AND SECTIONS 4-201 AND 215, AND THE CODE OF MARYLAND REGULATIONS (COMAR) 26.17.01 AND COMAR 26.17.02 FOR EROSION AND SEDIMENT CONTROL AND STORMWATER MANAGEMENT, RESPECTIVELY.

_ DESIGNER'S SIGNATURE ____ DONG ZHAO, P.E. MD REGISTRATION NO.___ _ PRINTED NAME (P.E.), R.L.S., R.L.A., OR R.A. (CIRCLE ONE)

REVISIONS EROSION AND SEDIMENT CONTROL GENERAL NOTES SCALE NTS DATE APRIL 12, 2022 CONTRACT NO. PGA115133 COUNTY PRINCE GEORGE'S DRAWN BY LOGMILE HORIZONTAL SCALE ___ CHECKED BY

ES-01 OF

FILE: P:\SHA\MD 725 ADA\00_Working\pES-N100_MD725.dgn

RJM ENGINEERING

CRITERIA

THE CONTRACTOR SHALL BE GOVERNED BY THE STANDARDS AND REQUIREMENTS OF THE FOLLOWING PUBLICATIONS, EXCEPT AS MODIFIED BY THE SPECIAL PROVISIONS OF THIS CONTRACT:

<u>DESIGN</u>

MDOT SHA - "MARYLAND MANUAL ON UNIFORM TRAFFIC CONTROL DEVICES", 2011 EDITION AND SUBSEQUENT REVISIONS.(MDMUTCD)

A A S H T O - "HIGHWAY SAFETY DESIGN AND OPERATIONS GUIDE" -1997

A A S H T O - "STANDARD SPECIFICATIONS FOR STRUCTURAL SUPPORTS FOR HIGHWAY SIGNS LUMINAIRES AND TRAFFIC SIGNALS", 2001 EDITION (CATEGORY II FOR ALL OVERHEAD AND CANTILEVER SIGN STRUCTURES).

MATERIALS AND CONSTRUCTION

MDOT SHA - "STANDARD SPECIFICATIONS FOR CONSTRUCTION & MATERIALS", MOST CURRENT EDITION AND SUBSEQUENT REVISIONS AND SUPPLEMENTS.

MDOT SHA - "BOOK OF STANDARDS FOR HIGHWAY AND INCIDENTAL STRUCTURES",
MOST CURRENT EDITION AND SUBSEQUENT REVISIONS AND SUPPLEMENTS.

DESIGN WIND

100 MPH - WOOD SUPPORTS 10 YEAR RECURRENCE INTERVAL

100 MPH - GROUND MOUNT SIGN STEEL SUPPORTS
10 YEAR RECURRENCE INTERVAL

100 MPH - OVERHEAD AND CANTILEVER STRUCTURES 50 YEAR RECURRENCE INTERVAL

DESIGN STRESS

SOIL BEARING PRESSURE - S = 3,000 P.S.F. (ASSUMED)
SEE MATERIAL & CONSTRUCTION ABOVE AND SPECIAL PROVISIONS FOR DESIGN
STRESSES FOR STRUCTURAL STEEL, ALUMINUM, REINFORCING STEEL AND CONCRETE.

CHAMFER

ALL EXPOSED EDGES OF CONCRETE SHALL HAVE A 3/4" X 3/4" CHAMFER.

CLASSIFICATION OF SIGNS

SIGNS ARE DIVIDED INTO TWO (2) GENERAL CATEGORIES. B) PANELS

I. GUIDE SIGNS

A) STRUCTURAL TYPES
OH - OVERHEAD

C - CANTILEVER

GM - GROUND MOUNT, BREAKAWAY

OR NON-BREAKWAY
BM - BRIDGE MOUNTED

2. STANDARD SIGNS (REGULATORY, WARNING, ETC.)

B) PANELS

ALL DISTRICTS

MATERIAL - SHEET ALUMINUM COPY - DIRECT APPLIED

MATERIAL - EXTRUDED ALUMINUM

I) HIGH INTENSITY (NEW SIGNS AND

REVISIONS TO EXISTING SIGNS)

COPY - DIRECT APPLIED

A) STRUCTURAL TYPES
WOOD SUPPORTS
SQUARE TUBE

IDENTIFICATION OF SIGNS AND PANELS

GUIDE SIGNS

EACH GUIDE SIGN IS IDENTIFIED BY A SIGN NUMBER ON THE PLANS AND IN THE TABULATIONS. (GM-1. GM-2. GM-3. e+c)

SIGNS ON STRUCTURES ARE IDENTIFIED WITH A NUMBER AND WHERE VARIATIONS OCCUR, A LOWER CASE LETTER. (OH-Ia, OH-Ib, OH-Ic)

STANDARD SIGNS

STANDARD SIGNS ARE IDENTIFIED BY PANEL NUMBERS AND ARE CLASSIFIED AS FOLLOWS


- R REGULATORY W - WARNING
- M ROUTE MARKERS AND ACCESSORIES
- D DESTINATION AND MILEAGE PANELS
- S SCHOOL

PANELS SHALL BE DESIGNATED TO AGREE WITH MARYLAND STANDARD SIGN BOOK. EACH STANDARD SIGN IS IDENTIFIED FIRST BY THE SHEET NUMBER, THEN BY THE NUMERICAL ORDER OF THE SIGN AS IT APPEARS ON THE PLAN. FOR EXAMPLE SHEET SN 2.1-101,102,103, ETC. SHEET SN 2.2-201,202,203,ETC.

PANEL LAYOUT AND ALPHABETS

I. GUIDE SIGN PANEL LAYOUTS ARE BASED ON THE A.A.S.H.T.O. MANUALS NOTED ABOVE.
2. STANDARD SIGN PANEL LAYOUTS ARE BASED ON THE MDMUTCD WITH SPECIFICATIONS DETAILED IN THE MARYLAND STATE HIGHWAY ADMINISTRATION PUBLICATION, "STANDARD SIGN BOOK", AVAILABLE ONLINE AT http://apps.roads.maryland.gov/businesswithsha/bizstdsspecs/desmanualstdpub/publicationsonline/oots/internet_signbook.asp

ORIENTATION OF SIGN FACES

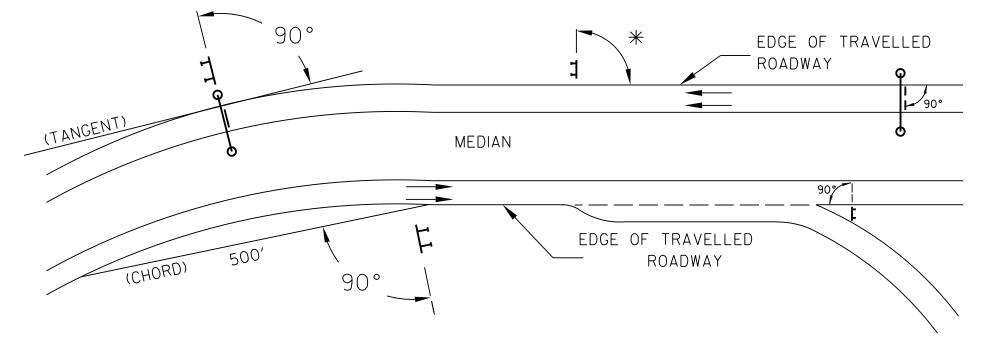

* UNDER 30 FEET FROM TRAVELLED ROADWAY TO NEAR EDGE OF SIGN - 93° AWAY FROM THE ROAD TO AVOID SPECULAR REFLECTION AS INDICATED IN 813.03 OF THE MARYLAND STANDARD SPECIFICATIONS FOR CONSTRUCTION AND MATERIALS.

OVER 30 FEET FROM TRAVELLED ROADWAY TO NEAR EDGE OF SIGN - 90°

REFLECTORIZATION

BACKGROUNDS, BORDERS, TEXTS AND ALL OTHER ELEMENTS OF SIGN PANELS SHALL BE REFLECTORIZED EXCEPT WHERE NOTED. REFER TO PROJECT REQUIREMENTS FOR MORE DETAIL.

SIGN LOCATIONS

I. GUIDE SIGNS ARE LOCATED ON THE PLANS BY DIMENSION TO SURVEY STATIONS, OR WHEN NECESSARY, TO IDENTIFIABLE PHYSICAL FEATURES.

2. ALL CHANGES IN THE LOCATIONS OF SIGNS AS SHOWN ON THE PLAN SHALL HAVE THE PRIOR APPROVAL OF THE ENGINEER.

EXISTING UTILITIES

THE ENGINEER DOES NOT WARRANT OR GUARANTEE THE ACCURACY OR COMPLETENESS OF UTILITY INFORMATION SHOWN ON THE PLAN.IT SHALL BE THE RESPONSIBILITY OF THE CONTRACTOR TO LOCATE AND PROTECT ALL EXISTING FACILITIES WHICH MIGHT BE AFFECTED BY THIS WORK OR HIS OPERATION.

ROADSIDE SIGNS

I. VERTICAL ALIGNMENT

POSITION PANEL SO FACE IS PLUMB.

2. HORIZONTAL ALIGNMENT (SEE DIAGRAM ABOVE)

A) ON STRAIGHT ROADWAY SECTIONS ANGLE OF S

A) ON STRAIGHT ROADWAY SECTIONS, ANGLE OF SIGN FACE TO ROADWAY VARIES WITH DISTANCE FROM TRAVELLED ROADWAY TO NEAR EDGE OF SIGN - SEE DIAGRAM.

B) ON THE INSIDE OF HORIZONTAL CURVES, POSITION SIGN SO FACE OF PANEL MAKES AN ANGLE OF 90° WITH A CHORD BETWEEN A POINT ON NEAR EDGE OF PAVEMENT AT SIGN LOCATION AND A POINT ON EDGE OF PAVEMENT 500' IN ADVANCE OF SIGN.

C) ON THE OUTSIDE OF HORIZONTAL CURVES, POSITION SIGN SO FACE OF PANEL IS AT RIGHT ANGLES TO THE TANGENT OF THE CURVE AT THE SIGN LOCATION.

D) POSITIONING OF SIGNS AT GORES AND RAMP SEPARATIONS IS REFERRED TO THE NORMAL EDGE OF THE MAINLINE ROADWAY.

OVERHEAD SIGNS

I. VERTICAL ALIGNMENT

POSITION PANELS FOR ALL OVERHEAD STRUCTURES SO THAT PANEL FACE IS PLUMB.

2. OVERHEAD SIGN STRUCTURES SHALL NOT BE ERECTED WITHOUT ATTACHING LUMINAIRES, SUPPORTS, AND/OR SIGNS.

3. HORIZONTAL ALIGNMENT

A) POSITION ALL OVERHEAD SIGNS SO THAT THE FACE OF THE PANEL IS AT RIGHT ANGLES TO THE NORMAL EDGE OF ROADWAY, IF ON A STRAIGHT ROADWAY SECTION.

B) POSITION ALL OVERHEAD SIGNS SO THAT THE FACE OF THE PANEL IS AT RIGHT ANGLES TO THE TANGENT OF THE CURVE AT SIGN LOCATION, IF ON A HORIZONTAL CURVE.

C) POSITIONING OF SIGNS AT GORES AND RAMP SEPARATIONS IS REFERRED TO THE NORMAL EDGE OF THE MAINLINE ROADWAY.

4. VERTICAL CLEARANCE

A) OVERHEAD SIGNS SHALL HAVE A MINIMUM VERTICAL CLEARANCE OF 17'-9" FROM ROADWAY TO THE BOTTOM OF LIGHT FIXTURES. ALL LIGHT FIXTURES ARE TO BE AT THE SAME ELEVATION.

B) IF THE CONTRACTOR CANNOT OBTAIN 17'-9" (SEE 3A) CLEARANCE, HE IS TO CEASE WORK

AND CONTACT THE PROJECT ENGINEER FOR FURTHER INSTRUCTIONS. THE PROJECT ENGINEER MAY CONTACT THE TRAFFIC ENGINEERING DESIGN DIVISION FOR ASSISTANCE.

C) ON ALL OVERHEAD SIGNS, THE MINIMUM CLEARANCE TO BOTTOM OF DESIGN SIGN: 20'-9".

PROJECT REQUIREMENTS

ALL NEW SIGNS ON THIS PROJECT SHALL BE FABRICATED FROM SHEETING WHICH MEETS ALL OF THE FOLLOWING REQUIREMENTS, UNLESS OTHERWISE SPECIFIED IN THE CONTRACT DOCUMENTS, OR AS DIRECTED BY THE ENGINEER:

I. SHEETING SHALL MEET THE REQUIREMENTS OF SECTIONS 813 AND 950.03 OF MDOT SHA'S STANDARD SPECIFICATIONS FOR CONSTRUCTION AND MATERIALS MOST CURRENT EDITION AND SUBSEQUENT REVISIONS AND SUPPLEMENTS.

2. LISTED ON MDOT SHA OFFICE OF TRAFFIC AND SAFETY'S QUALIFIED PRODUCTS LIST (QPL).

PROJECT REQUIREMENTS CONT'D

3. THE FOLLOWING TYPES OF SHEETING SHALL BE USED FOR THE SPECIFIED SIGN CLASSIFICATIONS:

GENERAL NOTE: ALL COLORS SHALL BE RETROREFLECTIVE EXCEPT BLACK. BLACK TEXT, BORDERS, SYMBOLS OR ANY BLACK ELEMENTS OF ANY SIGN SHALL BE NON-REFLECTIVE. THIS APPLIES TO ALL MDOT SHA SIGNS AS SHOWN BELOW.

A) GUIDE, EXIT GORE, GENERAL INFORMATION, AND SERVICE SIGNS - FALL INTO TWO SUB CATEGORIES:

(I). GROUND MOUNTED:

ALL RETROREFLECTIVE SHEETING ELEMENTS OF THESE SIGNS SHALL MEET OR EXCEED THE REQUIREMENTS FOR ASTM TYPE IX (9).

(II). OVERHEAD STRUCTURE SIGNS AND OVERHEAD CANTILEVER SIGNS:

ALL RETROREFLECTIVE SHEETING ELEMENTS OF ALL OVERHEAD SIGNS SHALL MEET OR EXCEED THE REQUIREMENTS
FOR ASTM TYPE XI(II). (THIS SECTION DOES NOT APPLY TO OVERHEAD SIGNALIZED INTERSECTION SIGNING; MAST
ARM OR SPAN WIRE. FOLLOW THE REQUIREMENTS FOR THE RESPECTIVE SIGN CLASSIFICATION FOR SIGNAL SIGNING.)

B) WARNING SIGNS - RETROREFLECTIVE SHEETING FOR WARNING SIGNS (FLUORESCENT YELLOW AND FLUORESCENT ORANGE) SHALL MEET OR EXCEED THE REQUIREMENTS FOR ASTM TYPE IX (9). REGULATORY MESSAGES WITHIN WARNING SIGNS SHALL FOLLOW THE REQUIREMENTS FOR REGULATORY SIGNS.

C) SCHOOL SIGNS - RETROREFLECTIVE SHEETING FOR SCHOOL SIGNS (FLUORESCENT YELLOW AND FLUORESCENT YELLOW-GREEN) SHALL MEET OR EXCEED THE REQUIREMENTS FOR ASTM TYPE IX (9). REGULATORY MESSAGES WITHIN SCHOOL SIGNS SHALL FOLLOW THE REQUIREMENTS FOR REGULATORY SIGNS.

D) REGULATORY SIGNS - FALL INTO THREE SUBCATEGORIES:

(1). "RED" REGULATORY SIGNS; (SPECIFICALLY - STOP, YIELD, DO NOT ENTER AND WRONG WAY). ALL RETROREFLECTIVE SHEETING ELEMENTS OF THESE SIGNS SHALL MEET OR EXCEED THE REQUIREMENTS FOR ASTM TYPE IX (9).

(II). ALL R7 AND R8 SERIES PARKING RELATED SIGNS AND THEIR SUPPLEMENTAL PANELS, NO TRESPASSING SIGNS, AND SIGNS DIRECTED AT PEDESTRIANS AND BICYCLISTS ONLY. ALL RETROREFLECTIVE SHEETING ELEMENTS OF THESE SIGNS SHALL MEET THE REQUIREMENTS FOR ASTM TYPE IV (4).

(III). ALL OTHER REGULATORY SIGNS - ALL RETROREFLECTIVE SHEETING ELEMENTS OF THESE SIGNS SHALL MEET ASTM TYPE IV (4) INCLUDING RED ELEMENTS. WARNING MESSAGES WITHIN REGULATORY SIGNS SHALL FOLLOW THE REQUIREMENTS FOR WARNING SIGNS.

E) ROUTE MARKERS (INDEPENDENT USE AND GUIDE SIGN USE)

INDEPENDENT USE: ALL RETROREFLECTIVE SHEETING ELEMENTS OF THESE SIGNS SHALL MEET BUT NOT TO EXCEED THE REQUIREMENTS FOR ASTM TYPE IV (4).

GUIDE SIGN USE: WHEN INCORPORATED IN THE BODY OF A GUIDE SIGN, ALL RETROREFLECTIVE SHEETING ELEMENTS OF THESE SIGNS SHALL MEET THE SHEETING REQUIREMENTS OF THE GUIDE SIGNS FOR WHICH THEY ARE TO BE APPLIED; GROUND MOUNT ASTM TYPE IX (9) OR OVERHEAD ASTM TYPE XI(II).

F)LOGOS AND / OR GRAPHICS - WITHIN SIGNS SHALL FOLLOW THE REQUIREMENTS FOR THE RESPECTIVE SIGN CLASSIFICATION UNLESS OTHERWISE SPECIFIED IN THE CONTRACT DOCUMENTS, OR AS DIRECTED BY THE ENGINEER.

G) SPECIFIC SERVICE (LOGO) SIGNING - ALL COPY, DIVIDER BORDERS, LOGOS AND ARROWS SHALL BE DEMOUNTABLE ALUMINUM OVERLAYS, .032 MINIMUM TO .063 MAXIMUM. ALL RETROREFLECTIVE SHEETING ELEMENTS OF THESE SIGNS SHALL MEET OR EXCEED THE REQUIREMENTS FOR ASTM TYPE IX (9). DISTANCES ON DIRECTIONAL ARROWS WHEN SPECIFIED SHALL BE BLACK. THE OVERLAYS ARE TO BE APPLIED WITH .125 ALUMINUM POP RIVETS TO THE BODY OF THE MAIN SIGN.

H) CIVIL DEFENSE SIGNS AND OTHER SIGNS - NOT SPECIFICALLY FALLING INTO ONE OF THE CATEGORIES ABOVE, SHALL FOLLOW THE GUIDELINES FOR THE SIGN CLASSIFICATION THAT MOST CLOSELY MATCHES THE COLOR(S) OF THE PROPOSED SIGN.

4. THE FOLLOWING MINIMUM THICKNESS SHALL BE USED FOR THE APPROPRIATE

WIDTH OF SHEET ALUMINUM BLANKS:

LONGEST DIMEN	MINIMUM THICKNESS	
UP TO 12"		0.040"
GREATER THAN	12" TO 24"	0.063"
GREATER THAN	24" TO 36"	0.080"
GREATER THAN	36" TO 48"	0.100"
OVER 48"		0.125"




OFFICE OF TRAFFIC & SAFETY
TRAFFIC ENGINEERING DESIGN DIVISION

MD 725 (MAIN STREET) FROM WEST OF SERVICE LANE TO EAST OF GOVERNOR ODEN BOWIE DRIVE SIDEWALKS

APPROVALS	REVISIONS	GENERAL NOTES AND PROPOSALS	
Pobert Stewart 01/11/22		SCALE N.T.S. DATE APRIL 12, 2022 CONTRACT NO. PGA115133	_
Adison Zoretic 1/12/2022 St. DIV. CHIEFO		DESIGNED BY JHR COUNTY PRINCE GEORGE'S DRAWN BY JHR LOGMILE 16072500.59 - 16072501.13 LOGMILE 16071700.26 - 16071700.33	
Jialin Tian 1/31/2022		CHECKED BY	-
Pedric Ward 2/2/22 FICE DIRECTOR		DRAWING NO. SN-1 OF 1 SHEET NO. 15 OF 29	



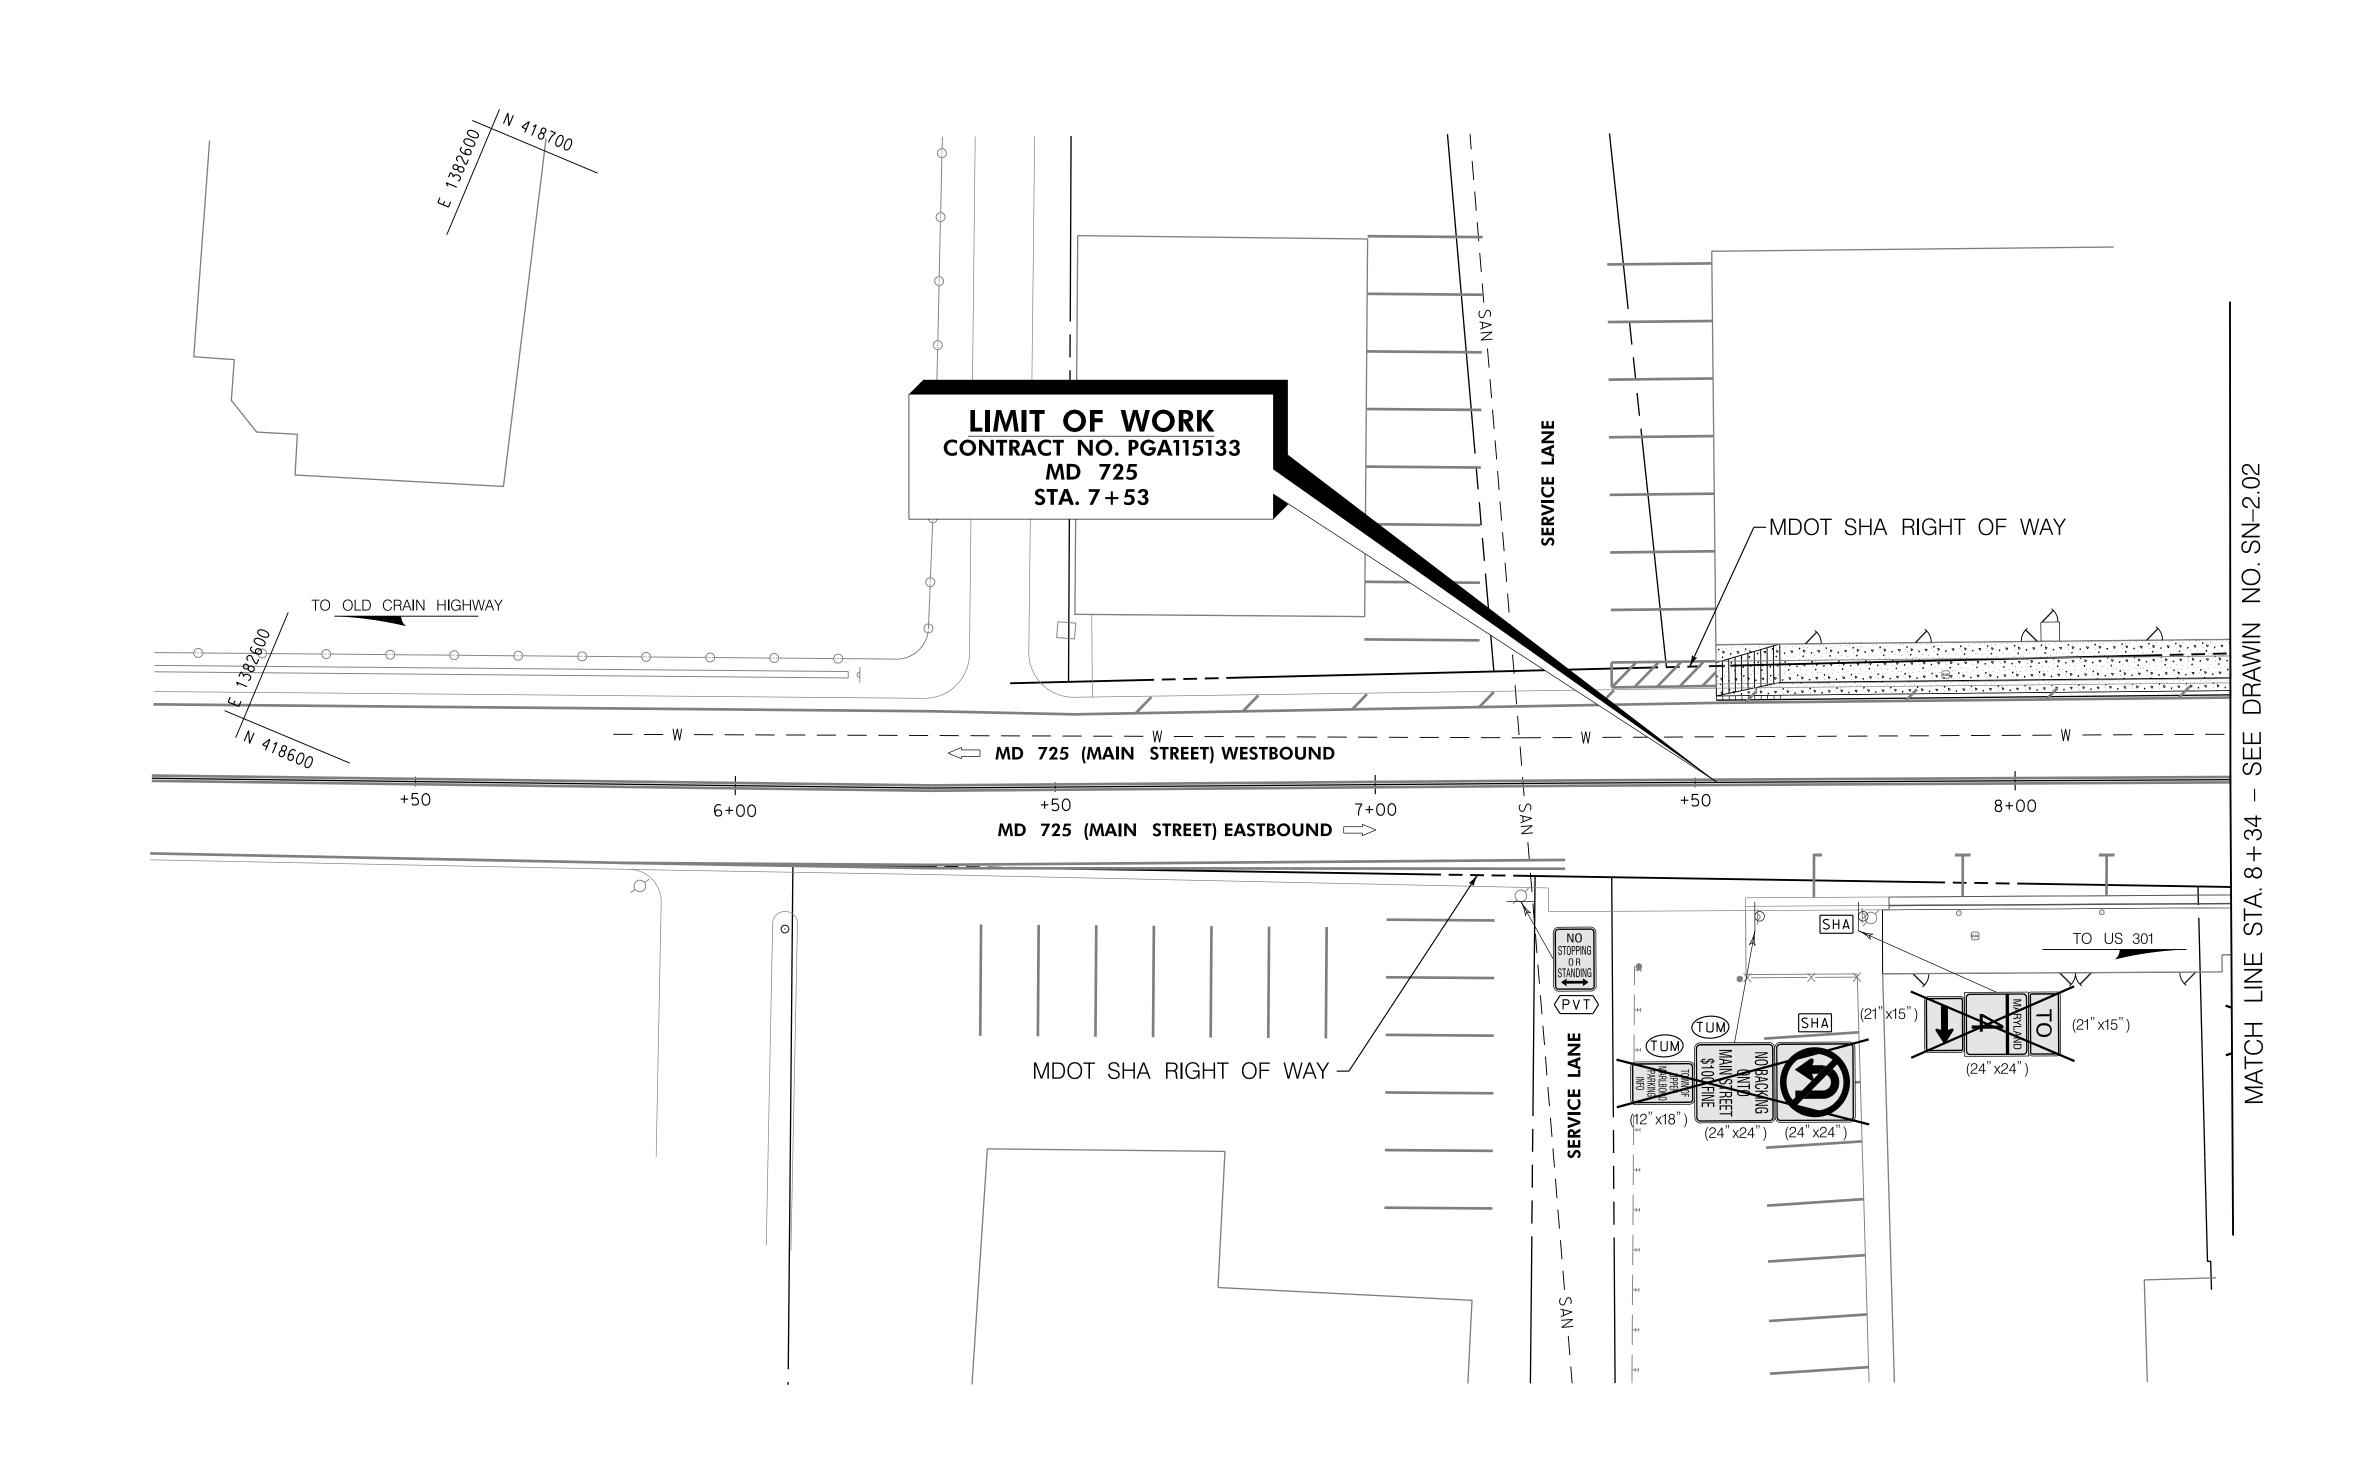

SIGN LEGEND

→ → EXISTING GROUND MOUNTED SIGN AND SUPPORT(S)

PROPOSED GROUND MOUNTED SIGN AND SUPPORT(S)

EXISTING SIGN TO REMAIN

EXISTING SIGN TO BE REMOVED

TRAFFIC FLOW ARROWS

SIGN NO.

FINAL OWNERSHIP AND MAINTENANCE RESPONSIBLITY:

SHA MDOT SHA

TUM TOWN OF UPPER MARLBORO

(PVT) PRIVATE

PGC\ PRINCE GEORGES COUNTY

GENERAL NOTES:

- 1. THE FOLLOWING MDOT SHA TEMPORARY TRAFFIC CONTROL TYPICAL APPLICATION (TTCTA) IS SUGGESTED FOR THE WORK SHOWN ON THIS PLAN: MD 104.02-10.
- 2. CONTRACTOR SHALL CONTACT MR. DARNELL BOND, DIRECTOR OF PUBLIC WORKS FOR THE TOWN OF UPPER MARLBORO AT dbond@uppermarlboromd.gov OR 301–509–4756 A MINIMUM OF 7 DAYS PRIOR TO REMOVAL OF SIGNS NOTED AS OWNED BY THE TOWN TO COORDINATE RETURN OF THE SIGNS TO THE TOWN.
- 3. EXISTING SIDEWALK, INCLUDING AREAS OF BRICK, DISTURBED BY SIGN SUPPORT REMOVAL SHALL BE RESTORED TO THE SATISFACTION OF THE ENGINEER.

PAVEMENT MARKING LEGEND

- A) 5 INCH SOLID WHITE THERMOPLASTIC PAVEMENT MARKINGS
- B 24 INCH SOLID WHITE PREFORMED THERMOPLASTIC PAVEMENT MARKINGS
- C REMOVE EXISTING PAVEMENT MARKING LINES, ANY WIDTH

MARYLAND DEPARTMENT OF TRANSPORTATION


STATE HIGHWAY ADMINISTRATION OFFICE OF TRAFFIC & SAFETY
TRAFFIC ENGINEERING DESIGN DIVISION

ADA SIDEWALK UPGRADES

MD 725 (MAIN STREET) FROM WEST OF SERVICE LANE TO EAST OF GOVERNOR ODEN BOWIE DRIVE

Whitman, Requardt & Associates, LLP 801 South Caroline Street, Baltimore, Maryland 21231

PLOTTED: December 16, 2021
FILE: N:\31933-017\CADD\Task 1_WRA_PG_MD 725 from Brown Station Road to MD 202\pSN-P001_MD725.dgn

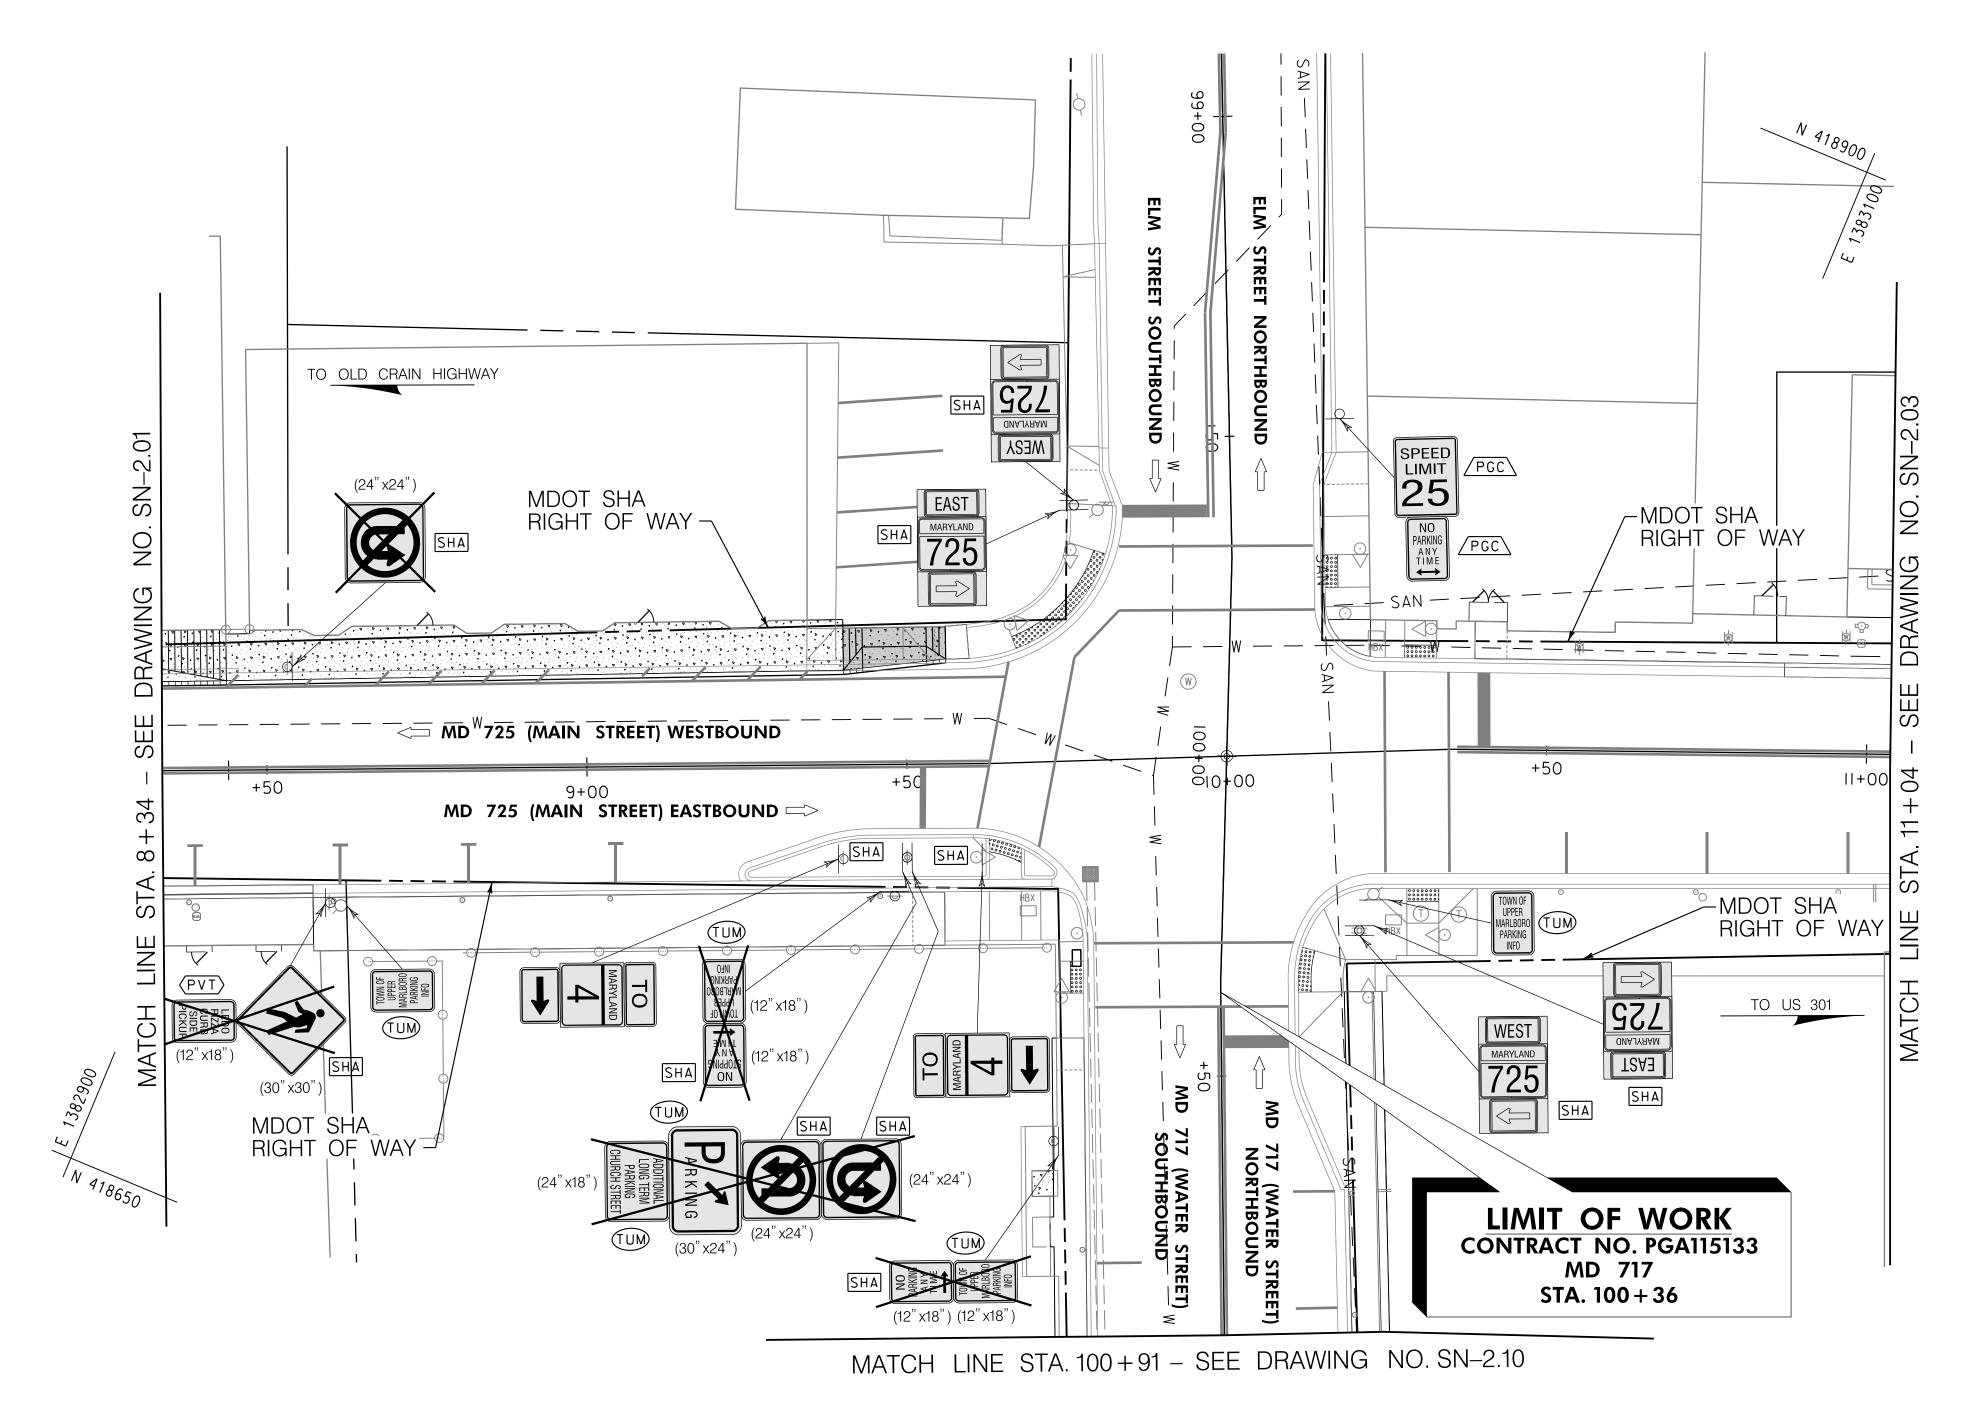

GENERAL NOTES:

- 1. THE FOLLOWING MDOT SHA TEMPORARY TRAFFIC CONTROL TYPICAL APPLICATION (TTCTA) IS SUGGESTED FOR THE WORK SHOWN ON THIS PLAN: MD 104.02–10.
- 2. CONTRACTOR SHALL CONTACT MR. DARNELL BOND, DIRECTOR OF PUBLIC WORKS FOR THE TOWN OF UPPER MARLBORO AT dbond@uppermarlboromd.gov OR 301-509-4756 A MINIMUM OF 7 DAYS PRIOR TO REMOVAL OF SIGNS NOTED AS OWNED BY THE TOWN TO COORDINATE RETURN OF THE SIGNS TO THE TOWN.
- 3. EXISTING SIDEWALK, INCLUDING AREAS OF BRICK, DISTURBED BY SIGN SUPPORT REMOVAL SHALL BE RESTORED TO THE SATISFACTION OF THE ENGINEER.



OFFICE OF TRAFFIC & SAFETY
TRAFFIC ENGINEERING DESIGN DIVISION

ADA SIDEWALK UPGRADES

ADA SIDEWALK OFGRADE

MD 725 (MAIN STREET) FROM WEST OF SERVICE LANE TO EAS

ON WEST OF SERVICE LANE TO EAST
OF GOVERNOR ODEN BOWIE DRIVE



EXISTING GROUND MOUNTED SIGN AND SUPPORT(S)

PROPOSED GROUND MOUNTED SIGN AND SUPPORT(S)

EXISTING SIGN TO REMAIN

EXISTING SIGN TO BE REMOVED

TRAFFIC FLOW ARROWS

SIGN NO.

FINAL OWNERSHIP AND MAINTENANCE RESPONSIBLITY:

MDOT SHA

TUM TOWN OF UPPER MARLBORO


(PVT) PRIVATE

PGC PRINCE GEORGES COUNTY


PAVEMENT MARKING LEGEND


- A) 5 INCH SOLID WHITE THERMOPLASTIC PAVEMENT MARKINGS
- B 24 INCH SOLID WHITE PREFORMED THERMOPLASTIC PAVEMENT MARKINGS
- PAVEMENT MARKINGS
- C REMOVE EXISTING PAVEMENT MARKING LINES, ANY WIDTH



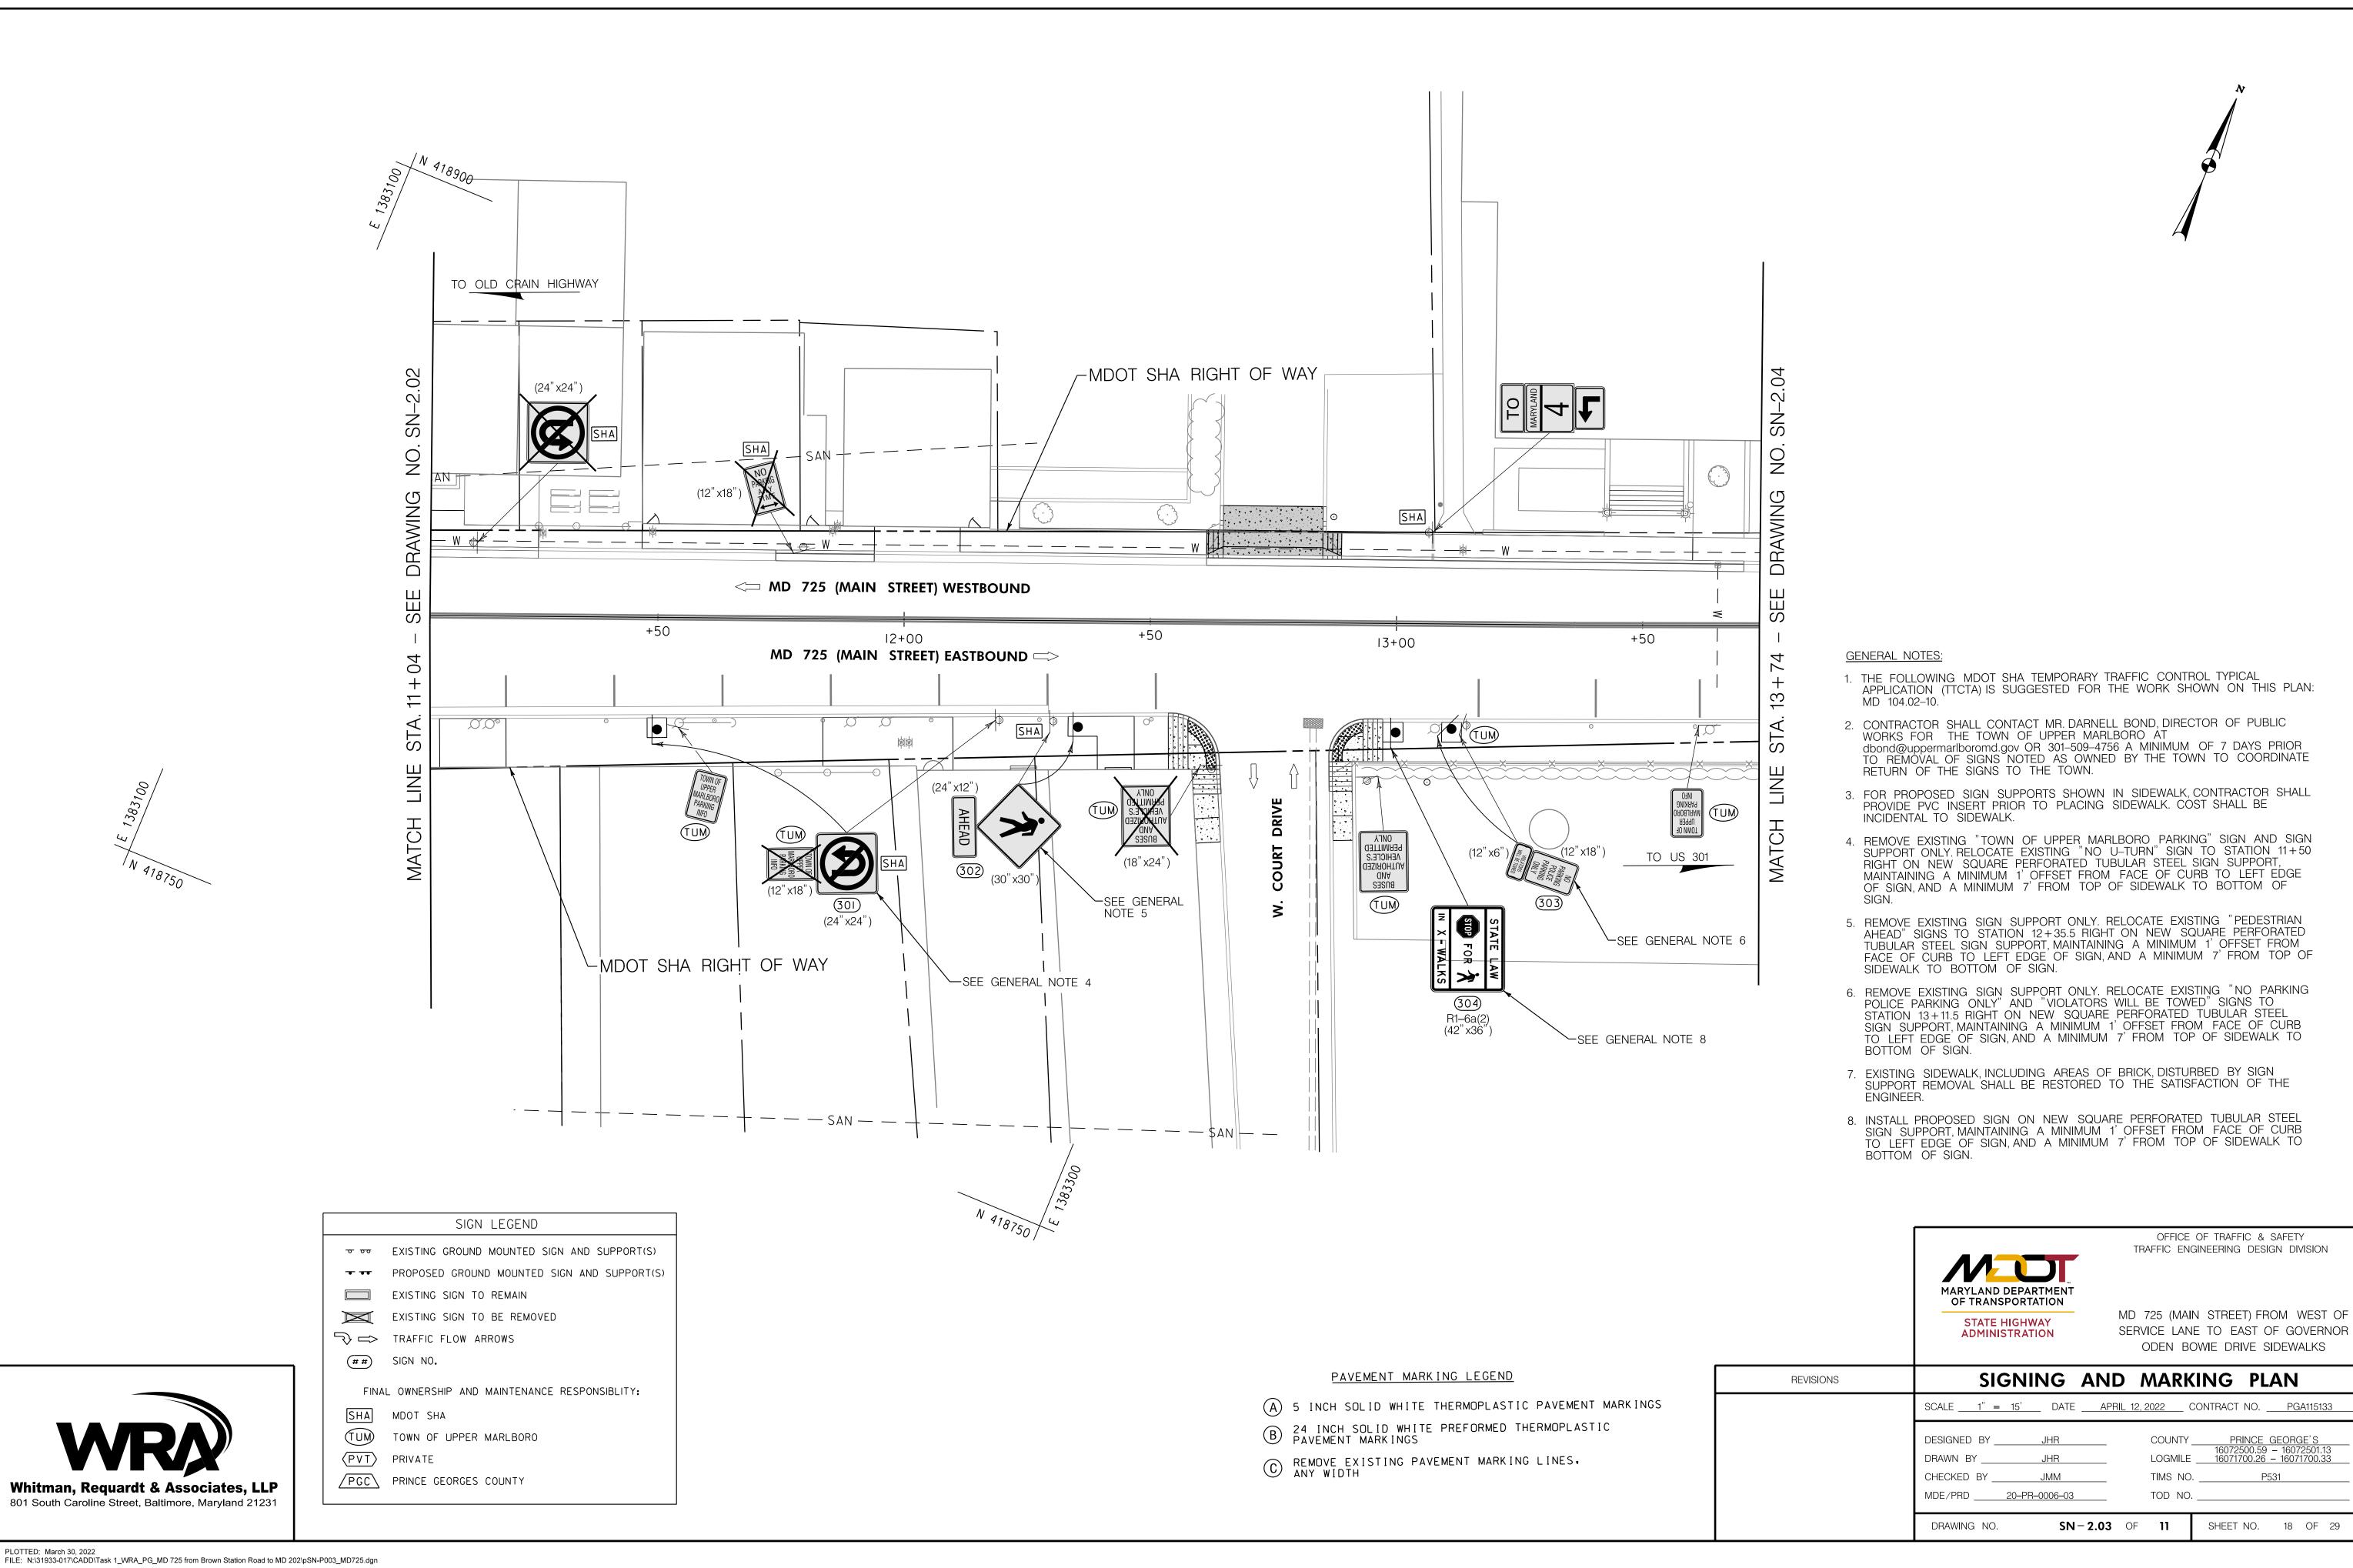

FILE: N:\31933-017\CADD\Task 1_WRA_PG_MD 725 from Brown Station Road to MD 202\pSN-P003_MD725.dgn

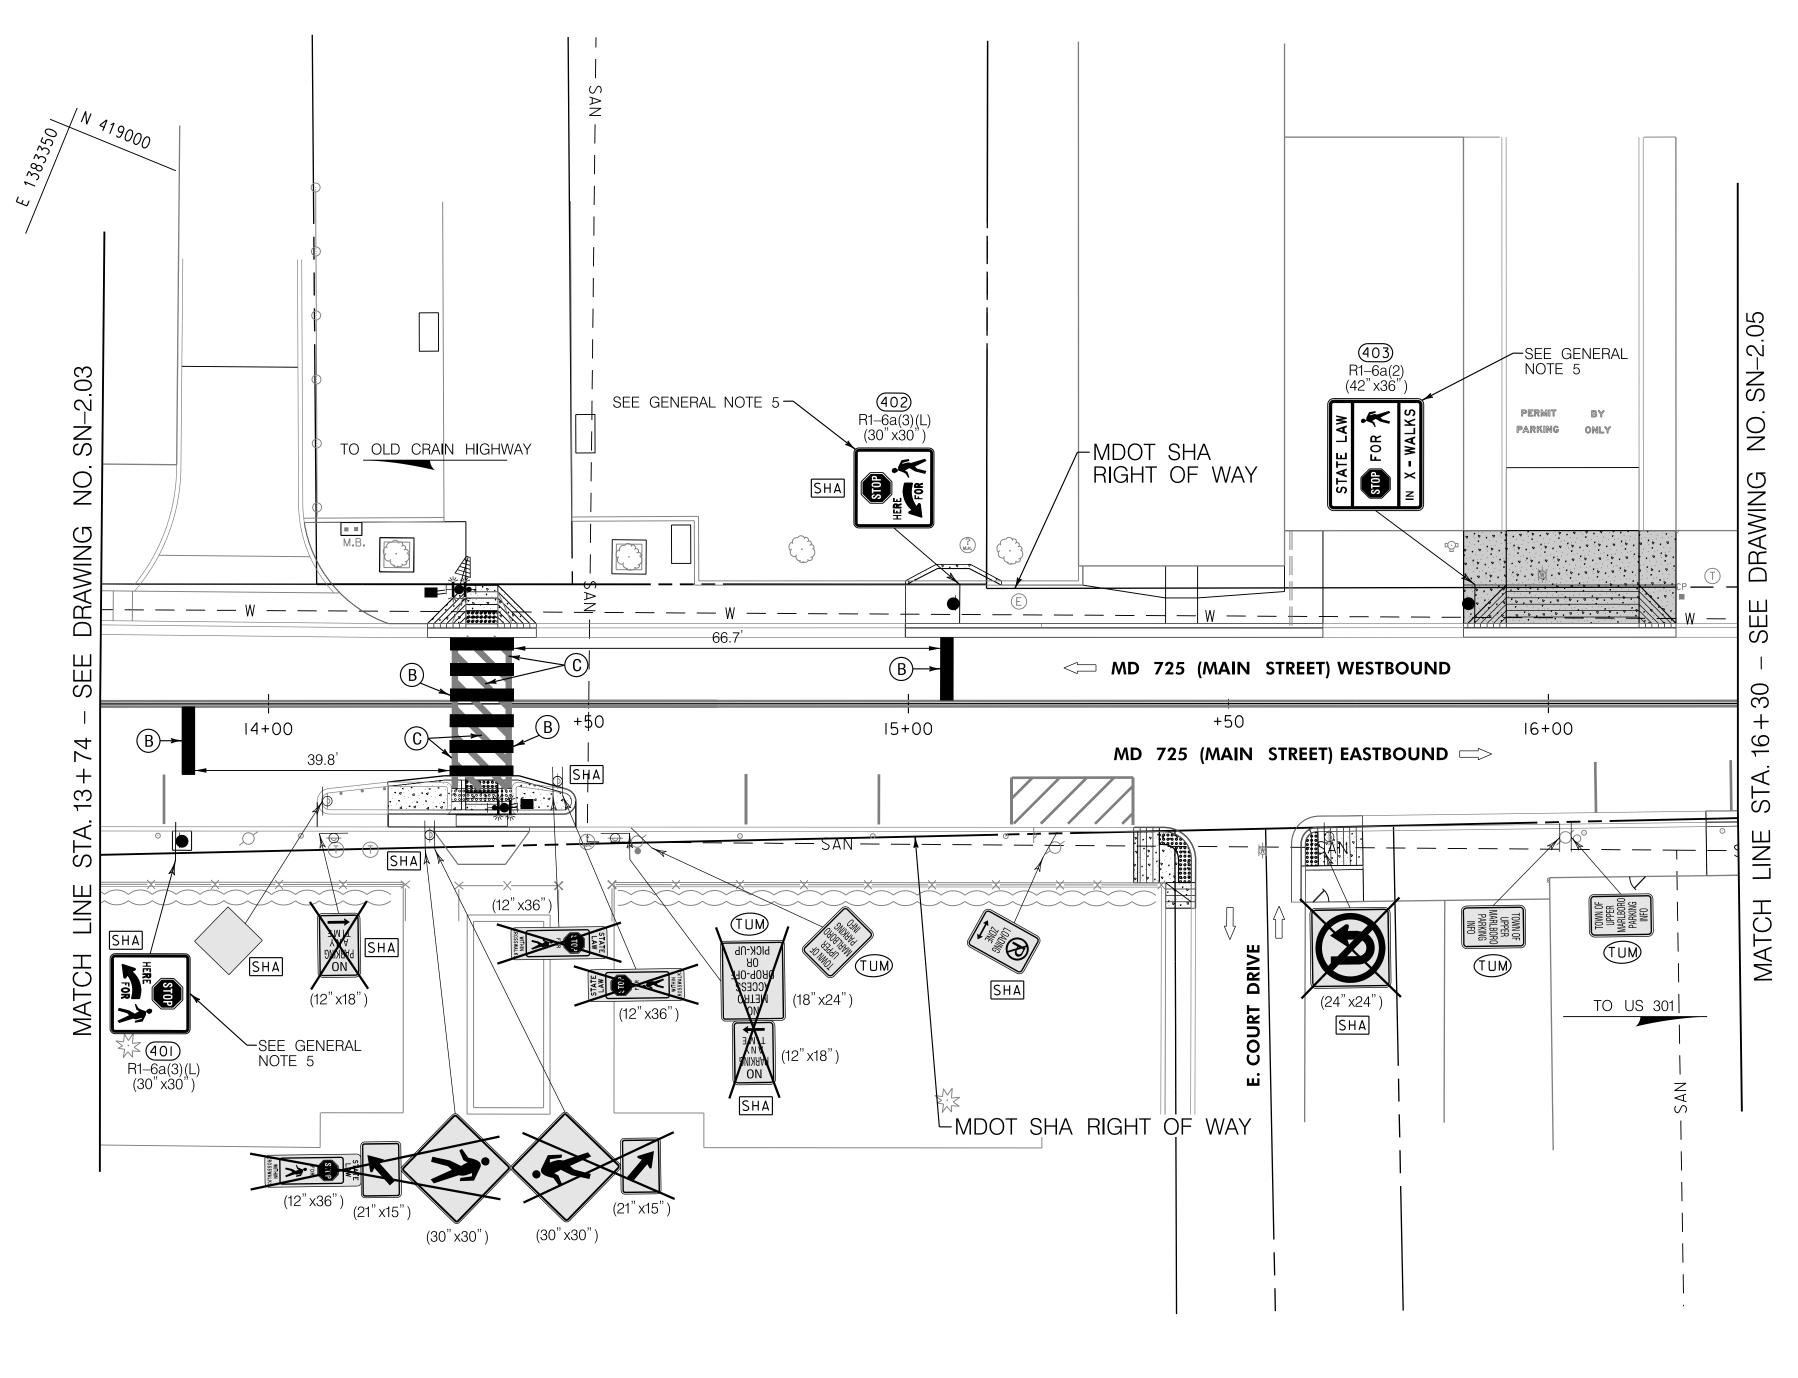

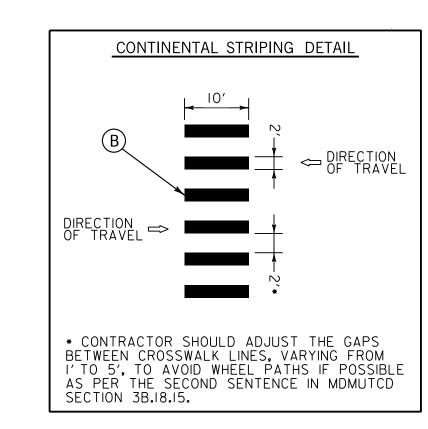

SIGN LEGEND

- •• EXISTING GROUND MOUNTED SIGN AND SUPPORT(S)
- PROPOSED GROUND MOUNTED SIGN AND SUPPORT(S)
- EXISTING SIGN TO REMAIN
- EXISTING SIGN TO BE REMOVED
- TRAFFIC FLOW ARROWS
- ## SIGN NO.
- FINAL OWNERSHIP AND MAINTENANCE RESPONSIBLITY:
- SHA MDOT SHA
- TUM TOWN OF UPPER MARLBORO
- (PVT) PRIVATE
- PGC PRINCE GEORGES COUNTY

GENERAL NOTES:

- 1. THE FOLLOWING MDOT SHA TEMPORARY TRAFFIC CONTROL TYPICAL APPLICATION (TTCTA) IS SUGGESTED FOR THE WORK SHOWN ON THIS PLAN: MD 104.02-10.
- 2. CONTRACTOR SHALL CONTACT MR. DARNELL BOND, DIRECTOR OF PUBLIC WORKS FOR THE TOWN OF UPPER MARLBORO AT dbond@uppermarlboromd.gov OR 301-509-4756 A MINIMUM OF 7 DAYS PRIOR TO REMOVAL OF SIGNS NOTED AS OWNED BY THE TOWN TO COORDINATE RETURN OF THE SIGNS TO THE TOWN.
- SEE SIGNAL PLANS FOR RECTANGULAR RAPID-FLASH BEACON AND PROPOSED PAVEMENT MARKING DETAILS.
- 4. EXISTING SIDEWALK, INCLUDING AREAS OF BRICK, DISTURBED BY SIGN SUPPORT REMOVAL SHALL BE RESTORED TO THE SATISFACTION OF THE ENGINEER.
- 5. INSTALL PROPOSED SIGN ON NEW SQUARE PERFORATED TUBULAR STEEL SIGN SUPPORT, MAINTAINING A MINIMUM 1 OFFSET FROM FACE OF CURB TO LEFT EDGE OF SIGN, AND A MINIMUM 7' FROM TOP OF SIDEWALK TO BOTTOM OF SIGN.

PAVEMENT MARKING LEGEND

- (A) 5 INCH SOLID WHITE THERMOPLASTIC PAVEMENT MARKINGS
- B 24 INCH SOLID WHITE PREFORMED THERMOPLASTIC PAVEMENT MARKINGS
- C REMOVE EXISTING PAVEMENT MARKING LINES, ANY WIDTH



STATE HIGHWAY

ADMINISTRATION

OFFICE OF TRAFFIC & SAFETY TRAFFIC ENGINEERING DESIGN DIVISION


MD 725 (MAIN STREET) FROM WEST OF SERVICE LANE TO EAST OF GOVERNOR ODEN BOWIE DRIVE SIDEWALKS

REVISIONS	SIGN	NING AN	ID MAR	KING F	PLAN	
	SCALE1" = 15	DATE A	APRIL 12, 2022	CONTRACT NO	D. <u>PGA115133</u>	
	DESIGNED BY	JHR	COUNT	Y PRINC		_
	DRAWN BY	JHR	LOGMIL		.59 – 16072501.13 .26 – 16071700.33	_
	CHECKED BY	JMM	_ TIMS N	IO	P531	_
	MDE/PRD <u>20-PR-0006-03</u>		TOD N	Ю		_
	DRAWING NO.	SN - 2.0	4 OF 11	SHEET NO). 19 OF 29	

Whitman, Requardt & Associates, LLP


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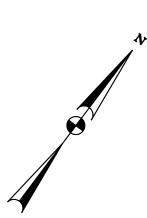


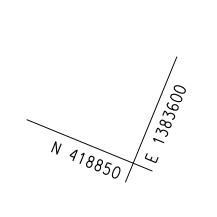



FILE: N:\31933-017\CADD\Task 1_WRA_PG_MD 725 from Brown Station Road to MD 202\pSN-P004_MD725.dgn

/N 418850



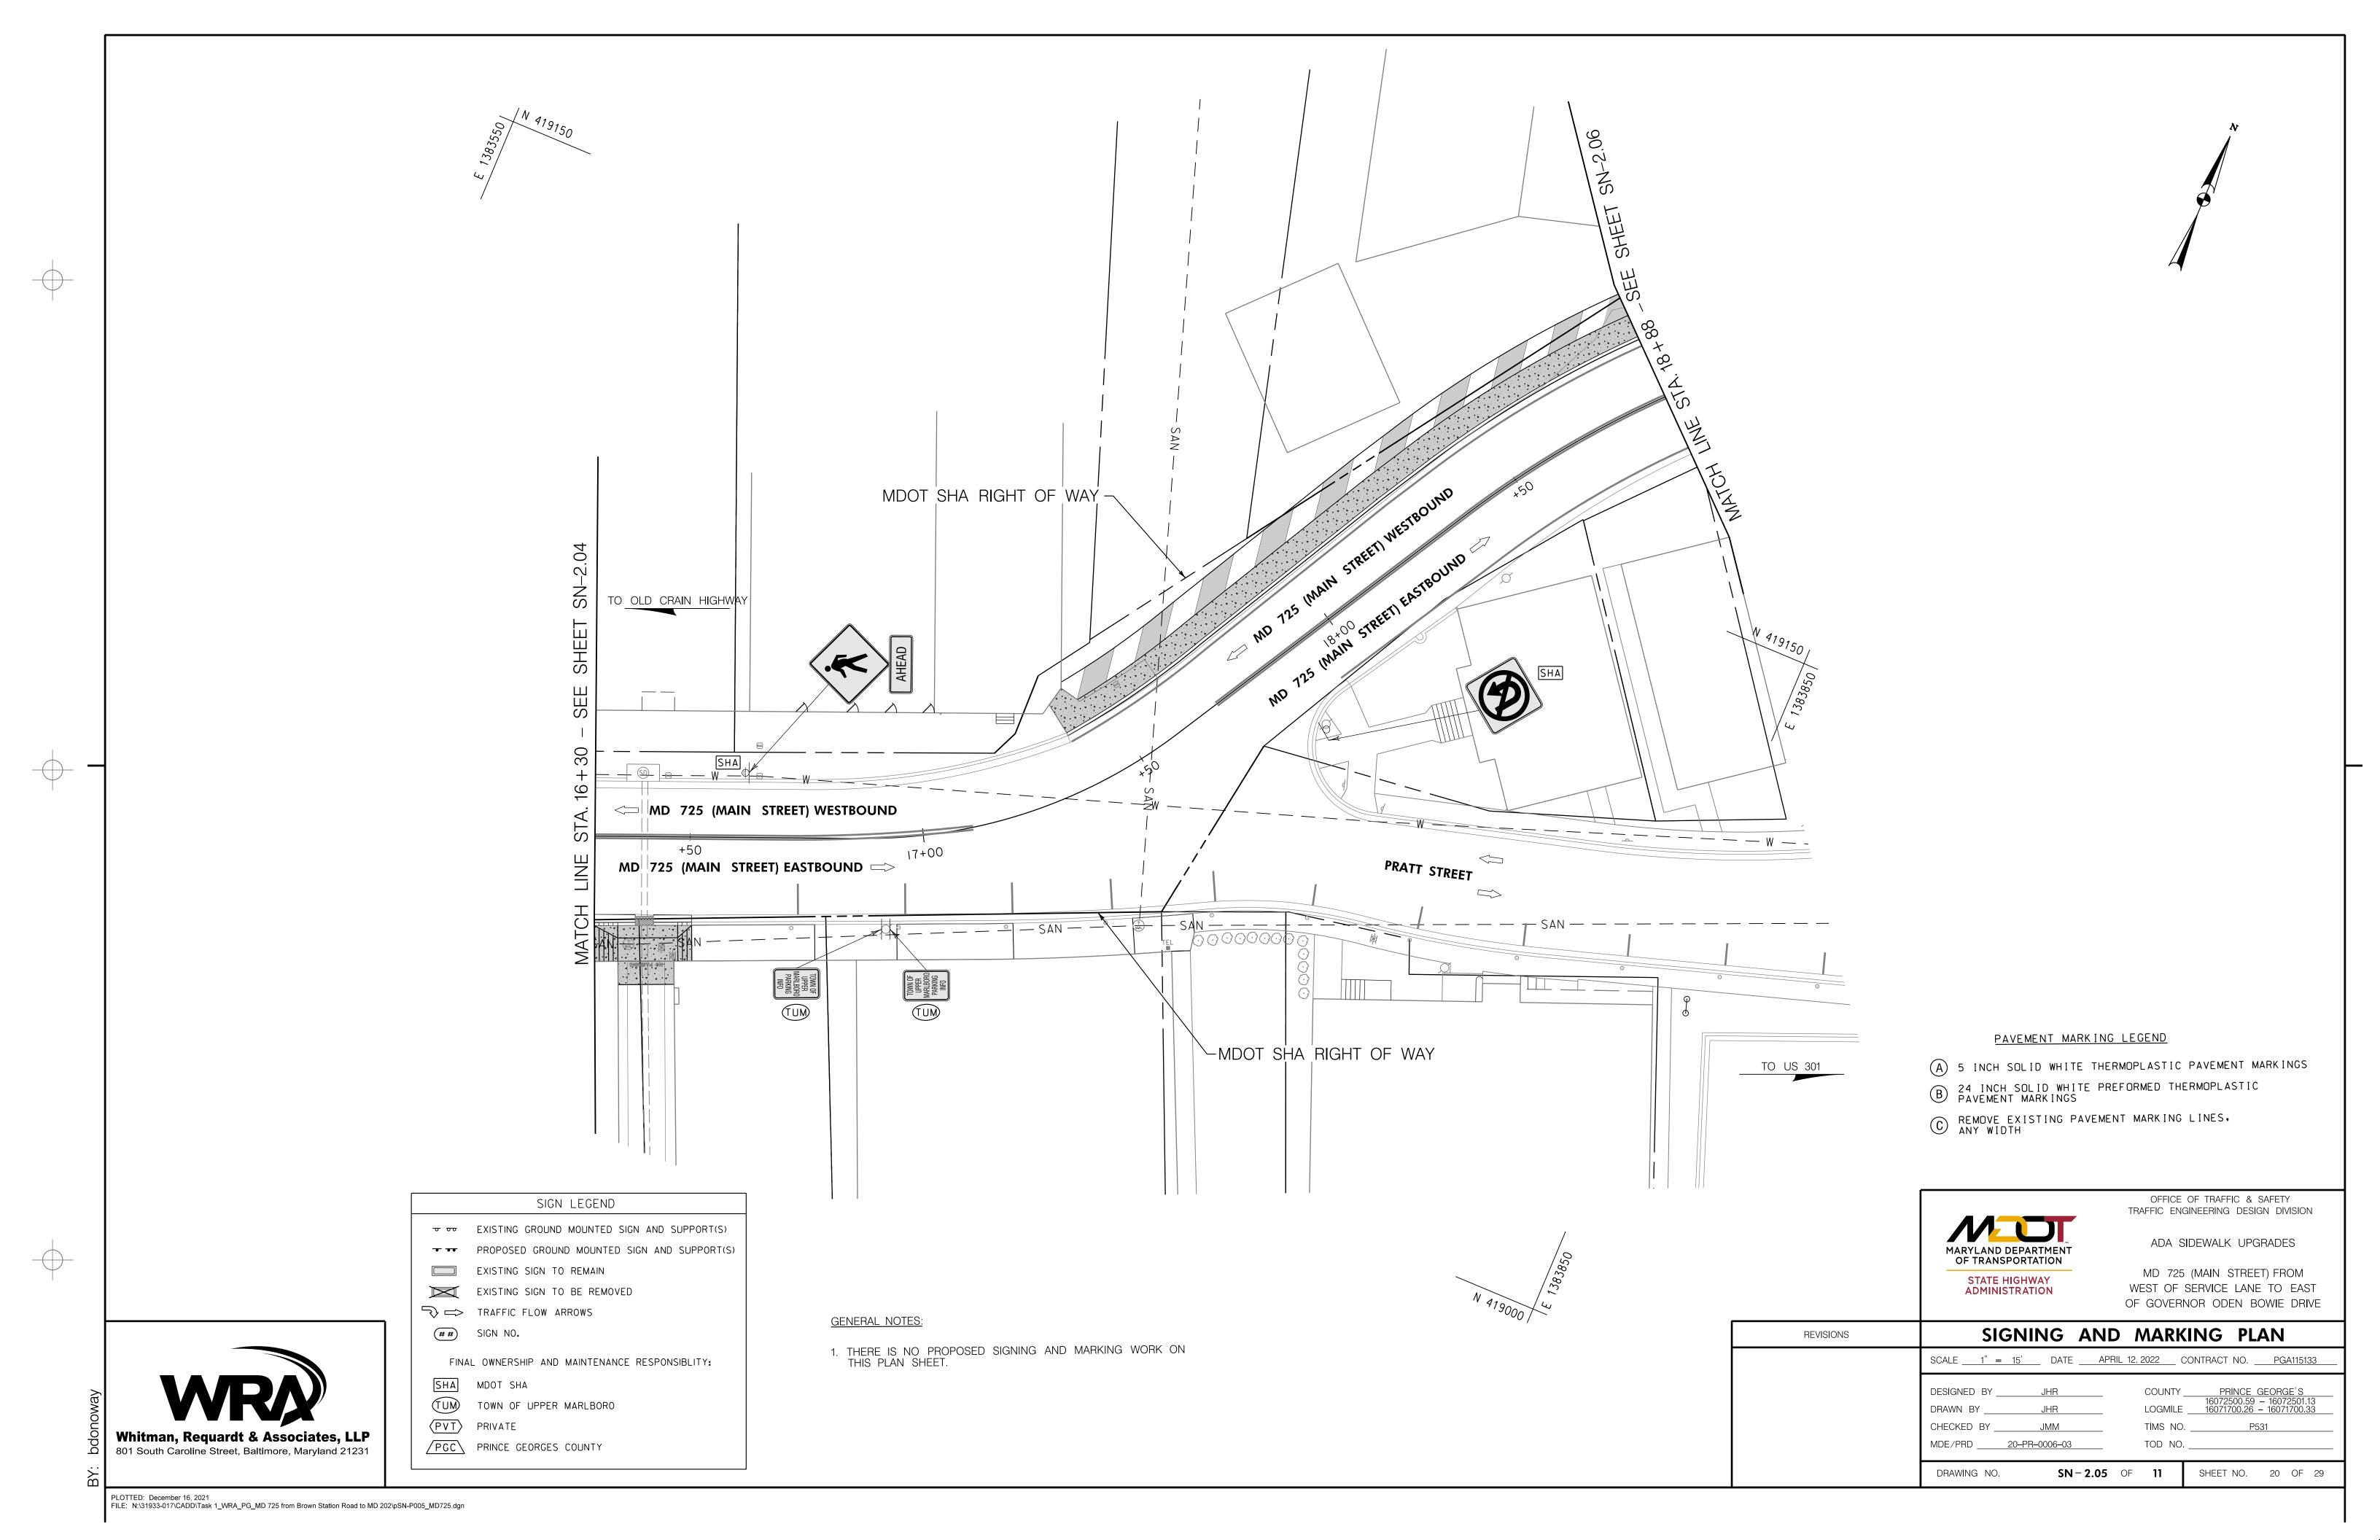

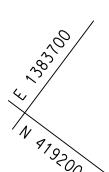

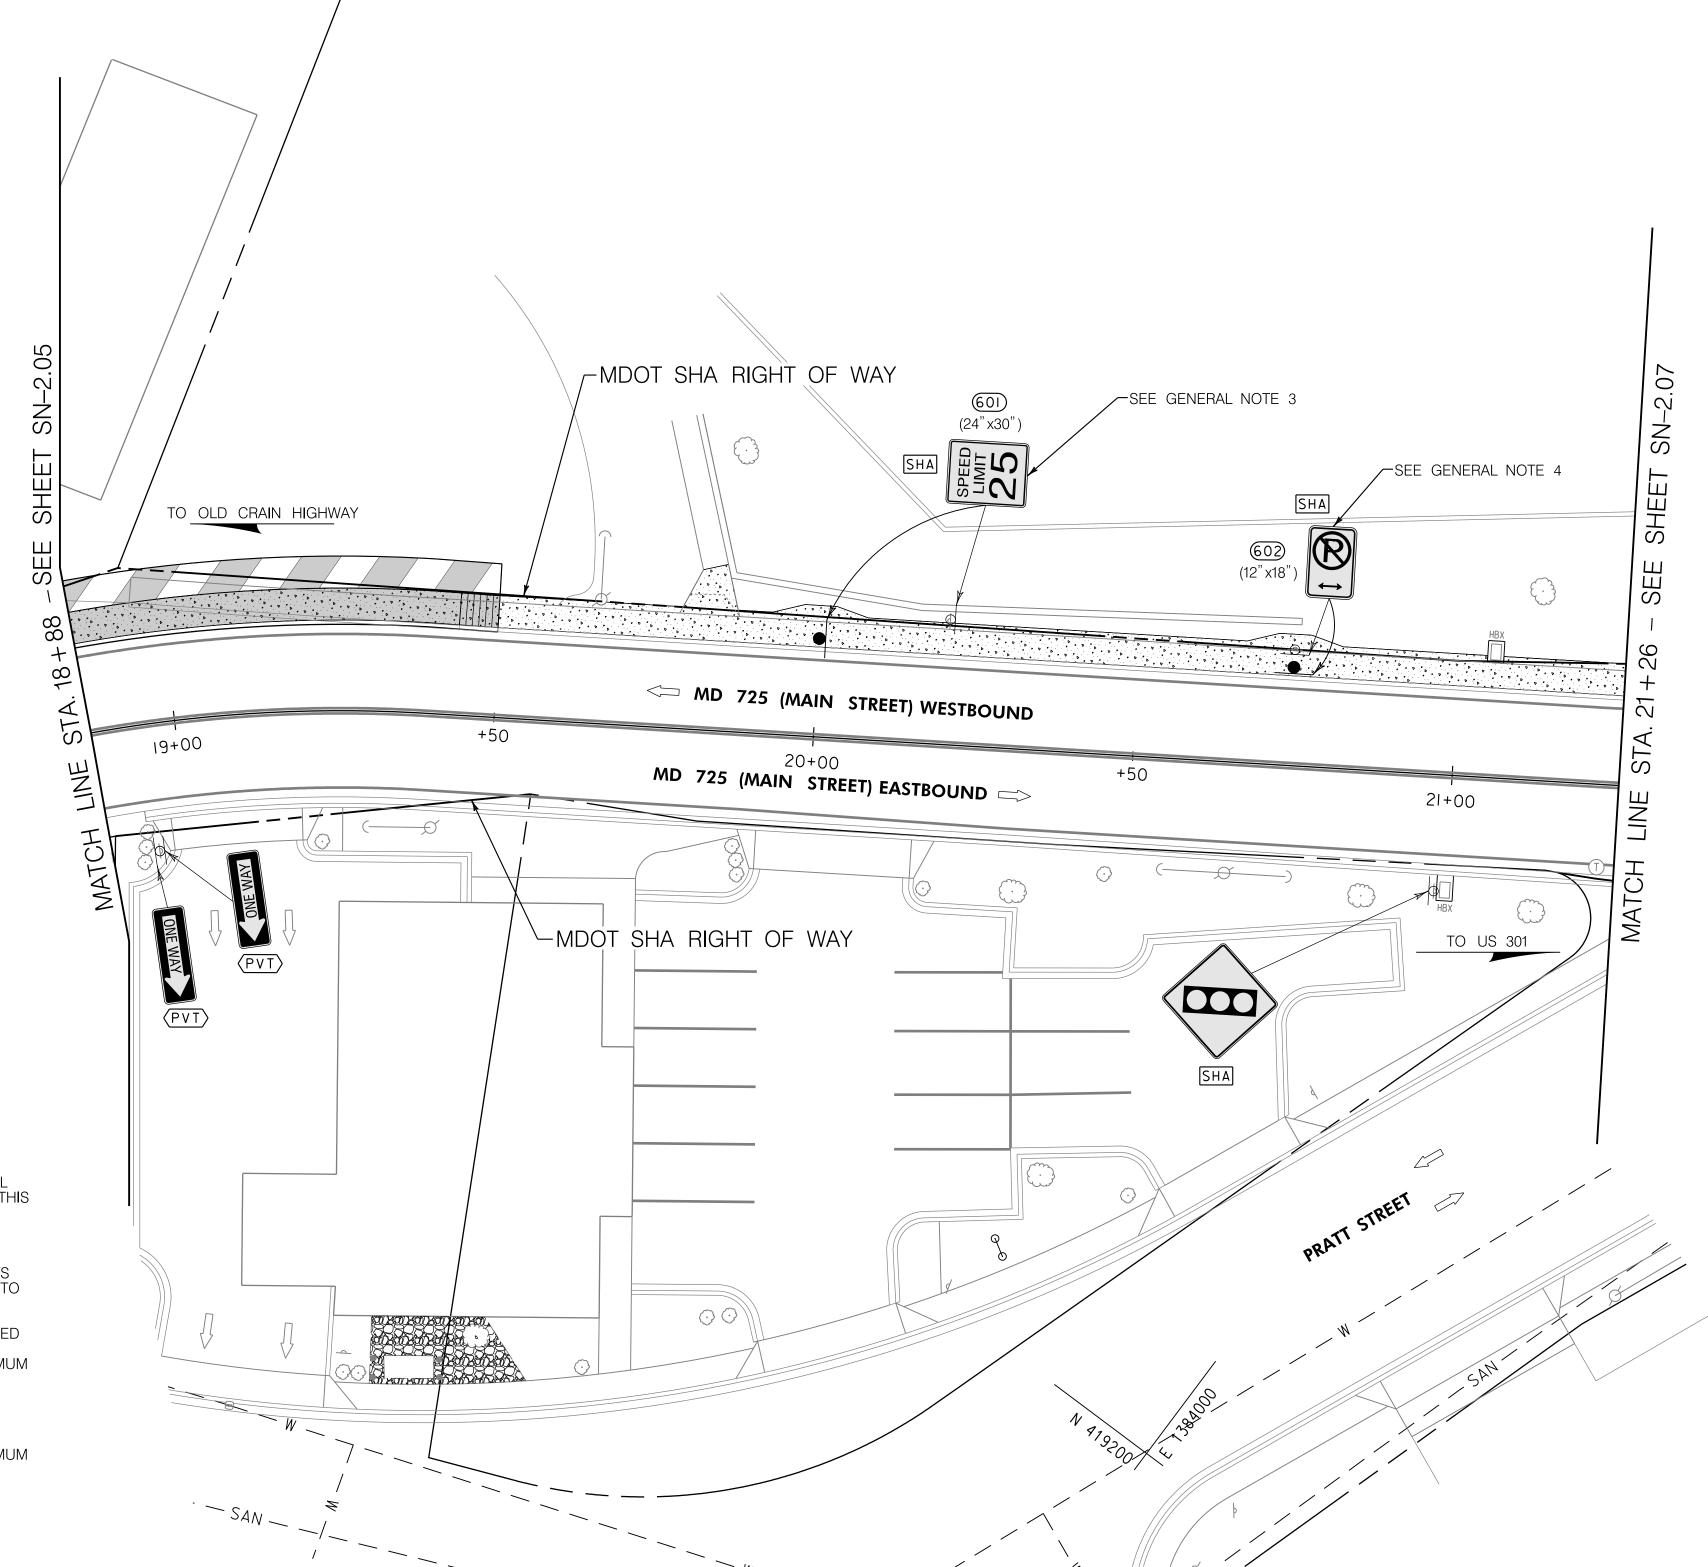

GENERAL NOTES:

- 1. THE FOLLOWING MDOT SHA TEMPORARY TRAFFIC CONTROL TYPICAL APPLICATION (TTCTA) IS SUGGESTED FOR THE WORK SHOWN ON THIS PLAN: MD 104.02–10.
- 2. CONTRACTOR SHALL CONTACT MR. DARNELL BOND, DIRECTOR OF PUBLIC WORKS FOR THE TOWN OF UPPER MARLBORO AT dbond@uppermarlboromd.gov OR 301-509-4756 A MINIMUM OF 7 DAYS PRIOR TO REMOVAL OF SIGNS NOTED AS OWNED BY THE TOWN TO COORDINATE RETURN OF THE SIGNS TO THE TOWN.
- 3. REMOVE EXISTING SIGN SUPPORT ONLY. RELOCATE EXISTING "SPEED LIMIT 25 MPH" SIGN TO STATION 20+00 LEFT ON NEW SQUARE PERFORATED TUBULAR STEEL SIGN SUPPORT, MAINTAINING A MINIMUM 1' OFFSET FROM FACE OF CURB TO LEFT EDGE OF SIGN, AND A MINIMUM 7' FROM TOP OF SIDEWALK TO BOTTOM OF SIGN.
- 4. REMOVE EXISTING SIGN SUPPORT ONLY. RELOCATE EXISTING "NO PARKING" SIGN TO STATION 20+74.3 LEFT ON NEW SQUARE PERFORATED TUBULAR STEEL SIGN SUPPORT, MAINTAINING A MINIMUM 2' OFFSET FROM FACE OF CURB TO FACE OF SIGN ORIENTED PARALLEL TO FACE OF CURB, AND A MINIMUM 7' FROM TOP OF SIDEWALK TO BOTTOM OF SIGN.

SIGN LEGEND

© © EXISTING GROUND MOUNTED SIGN AND SUPPORT(S)

PROPOSED GROUND MOUNTED SIGN AND SUPPORT(S)

EXISTING SIGN TO REMAIN

EXISTING SIGN TO BE REMOVED

TRAFFIC FLOW ARROWS

SIGN NO.

FINAL OWNERSHIP AND MAINTENANCE RESPONSIBLITY:

SIGNING AND MARKING PLAN

SHA MDOT SHA

TUM TOWN OF UPPER MARLBORO

(PVT) PRIVATE

PGC PRINCE GEORGES COUNTY



ADMINISTRATION

REVISIONS

OFFICE OF TRAFFIC & SAFETY
TRAFFIC ENGINEERING DESIGN DIVISION

ADA SIDEWALK UPGRADES

MD 725 (MAIN STREET) FROM WEST OF SERVICE LANE TO EAST

OF GOVERNOR ODEN BOWIE DRIVE



Whitman, Requardt & Associates, LLP 801 South Caroline Street, Baltimore, Maryland 21231 PAVEMENT MARKING LEGEND


(A) 5 INCH SOLID WHITE THERMOPLASTIC PAVEMENT MARKINGS


B 24 INCH SOLID WHITE PREFORMED THERMOPLASTIC PAVEMENT MARKINGS


C REMOVE EXISTING PAVEMENT MARKING LINES.
ANY WIDTH


SCALE1" =	: 15' DATE	APRIL 12, 2022 (CONTRACT NO. PGA115133
DESIGNED BY_	JHR	COUNTY	PRINCE GEORGE'S
DRAWN BY	JHR	_ LOGMILE	16072500.59 - 16072501.13 16071700.26 - 16071700.33
CHECKED BY _	JMM	_ TIMS NO.	P531
MDE/PRD	20-PR-0006-03	_ TOD NO.	
DRAWING NO.	SN - 2.0	06 OF 11	SHEET NO. 21 OF 29

PLOTTED: December 16, 2021
FILE: N:\31933-017\CADD\Task 1_WRA_PG_MD 725 from Brown Station Road to MD 202\pSN-P006_MD725.dgn

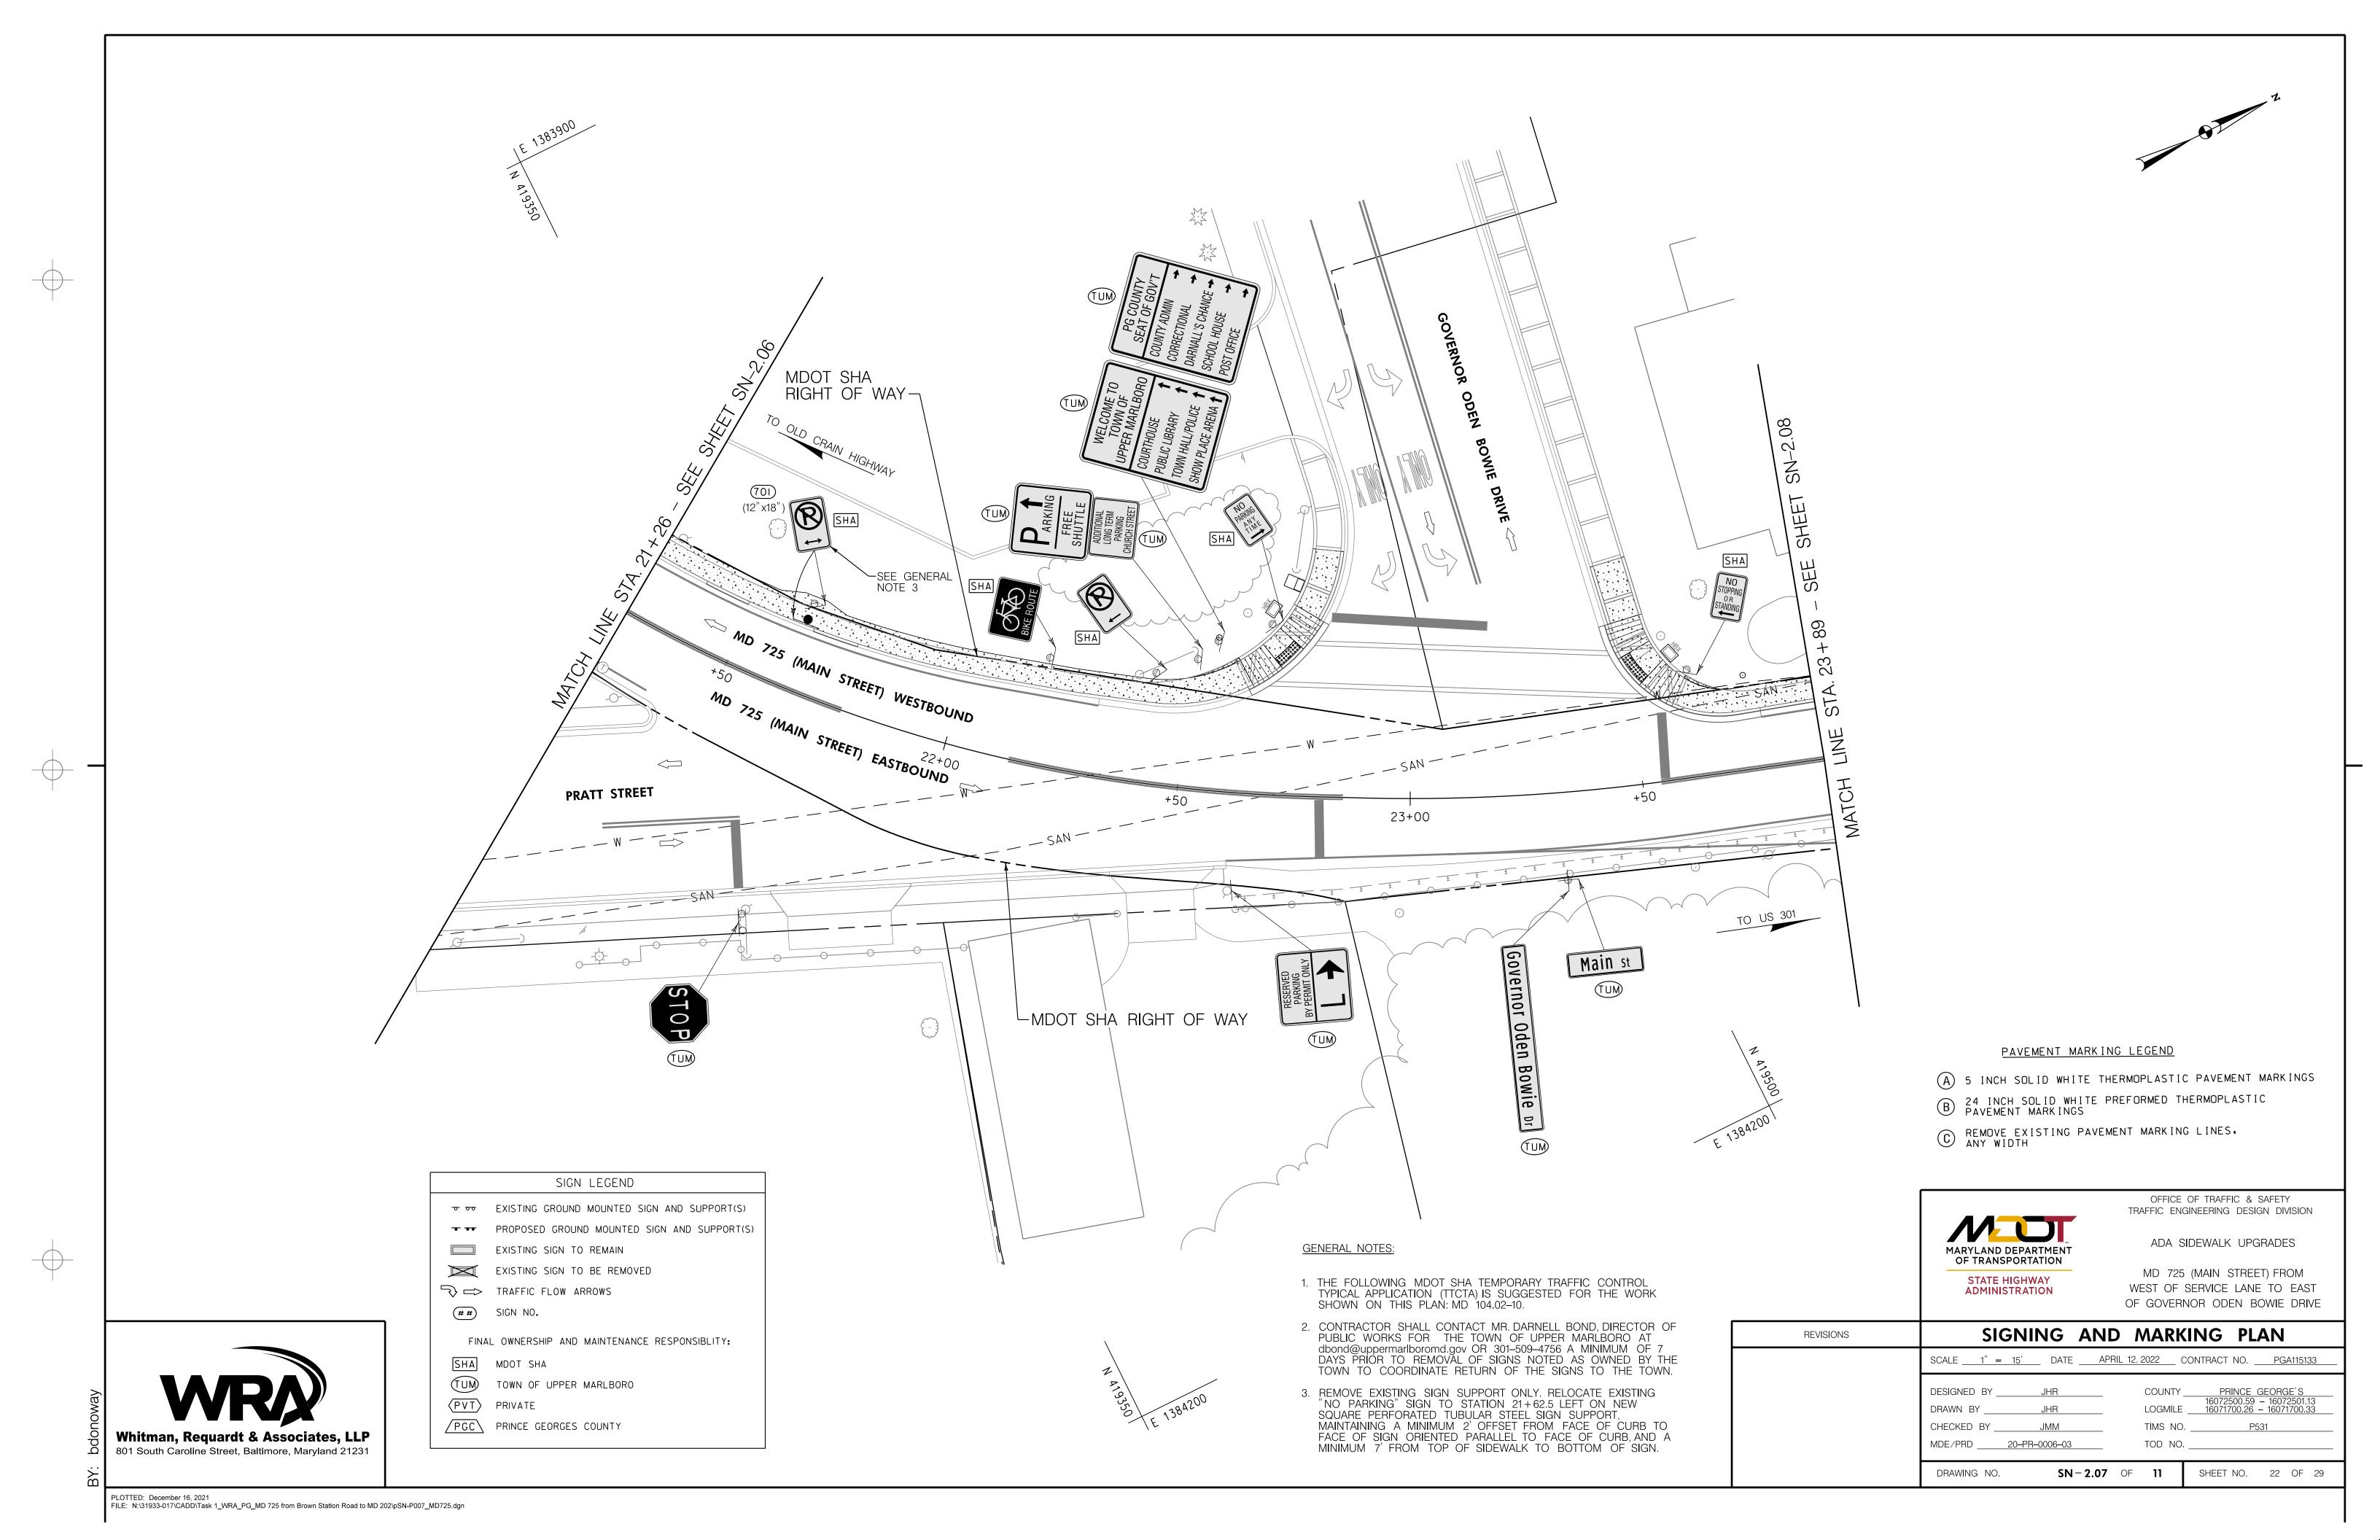


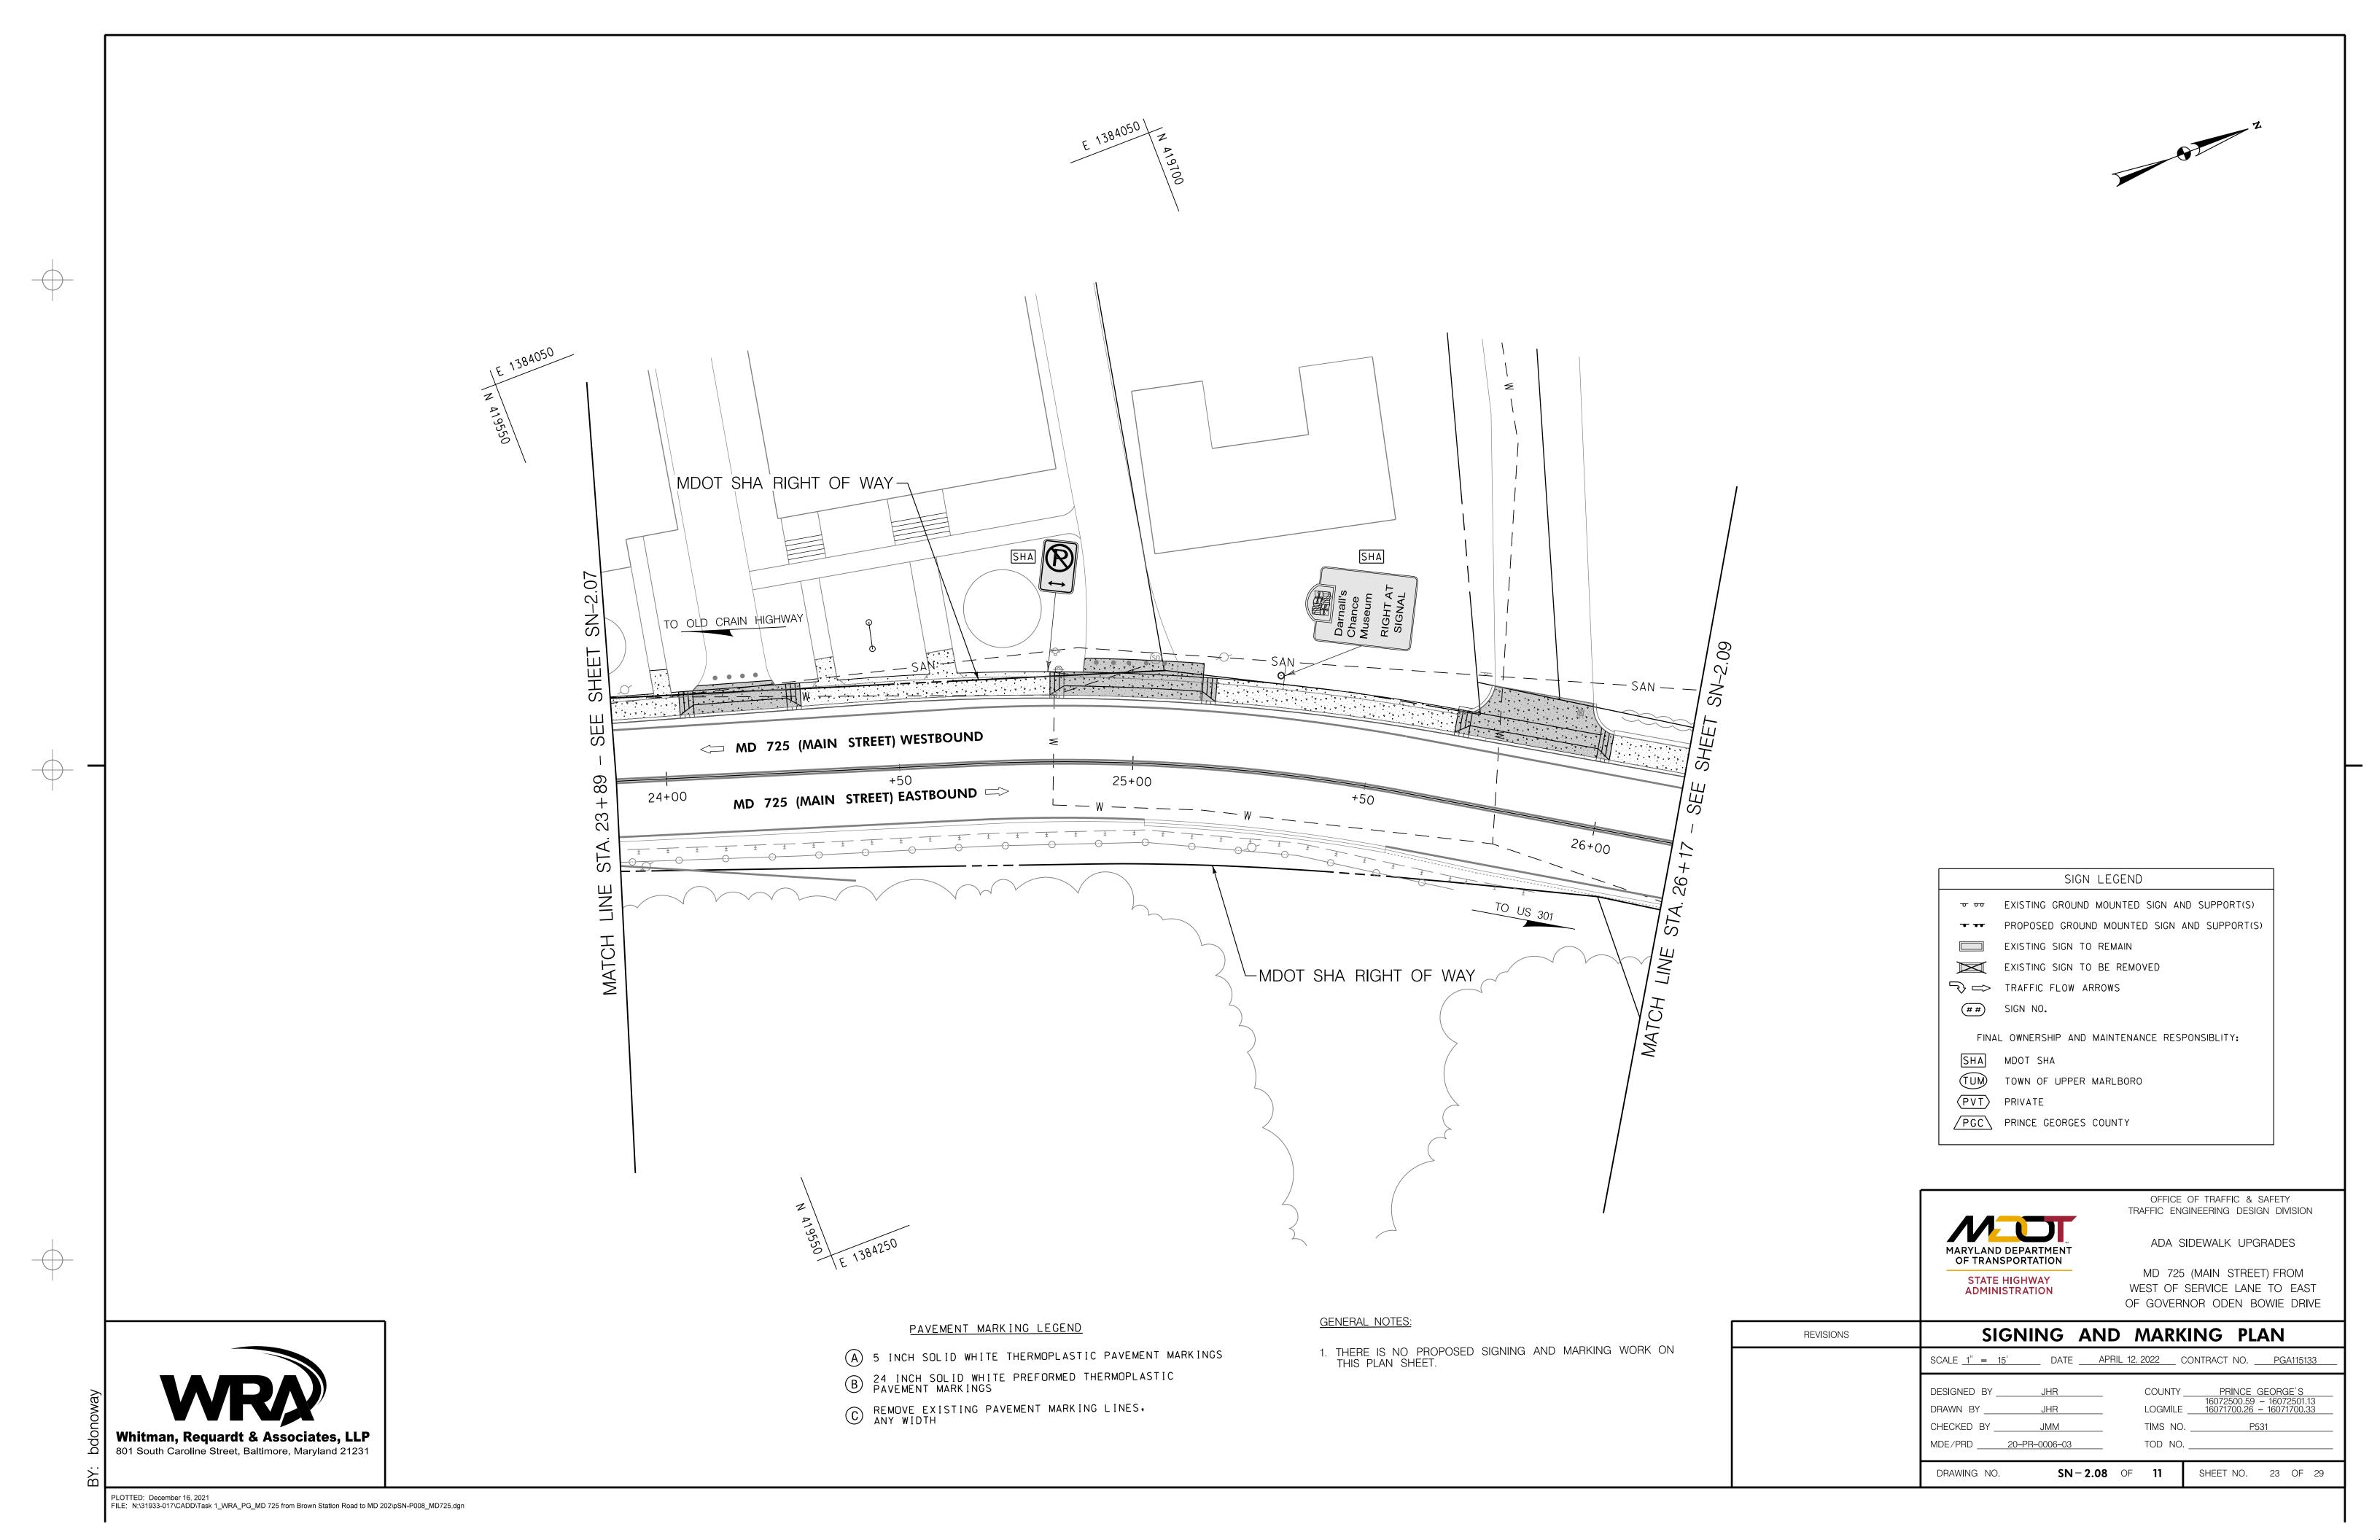

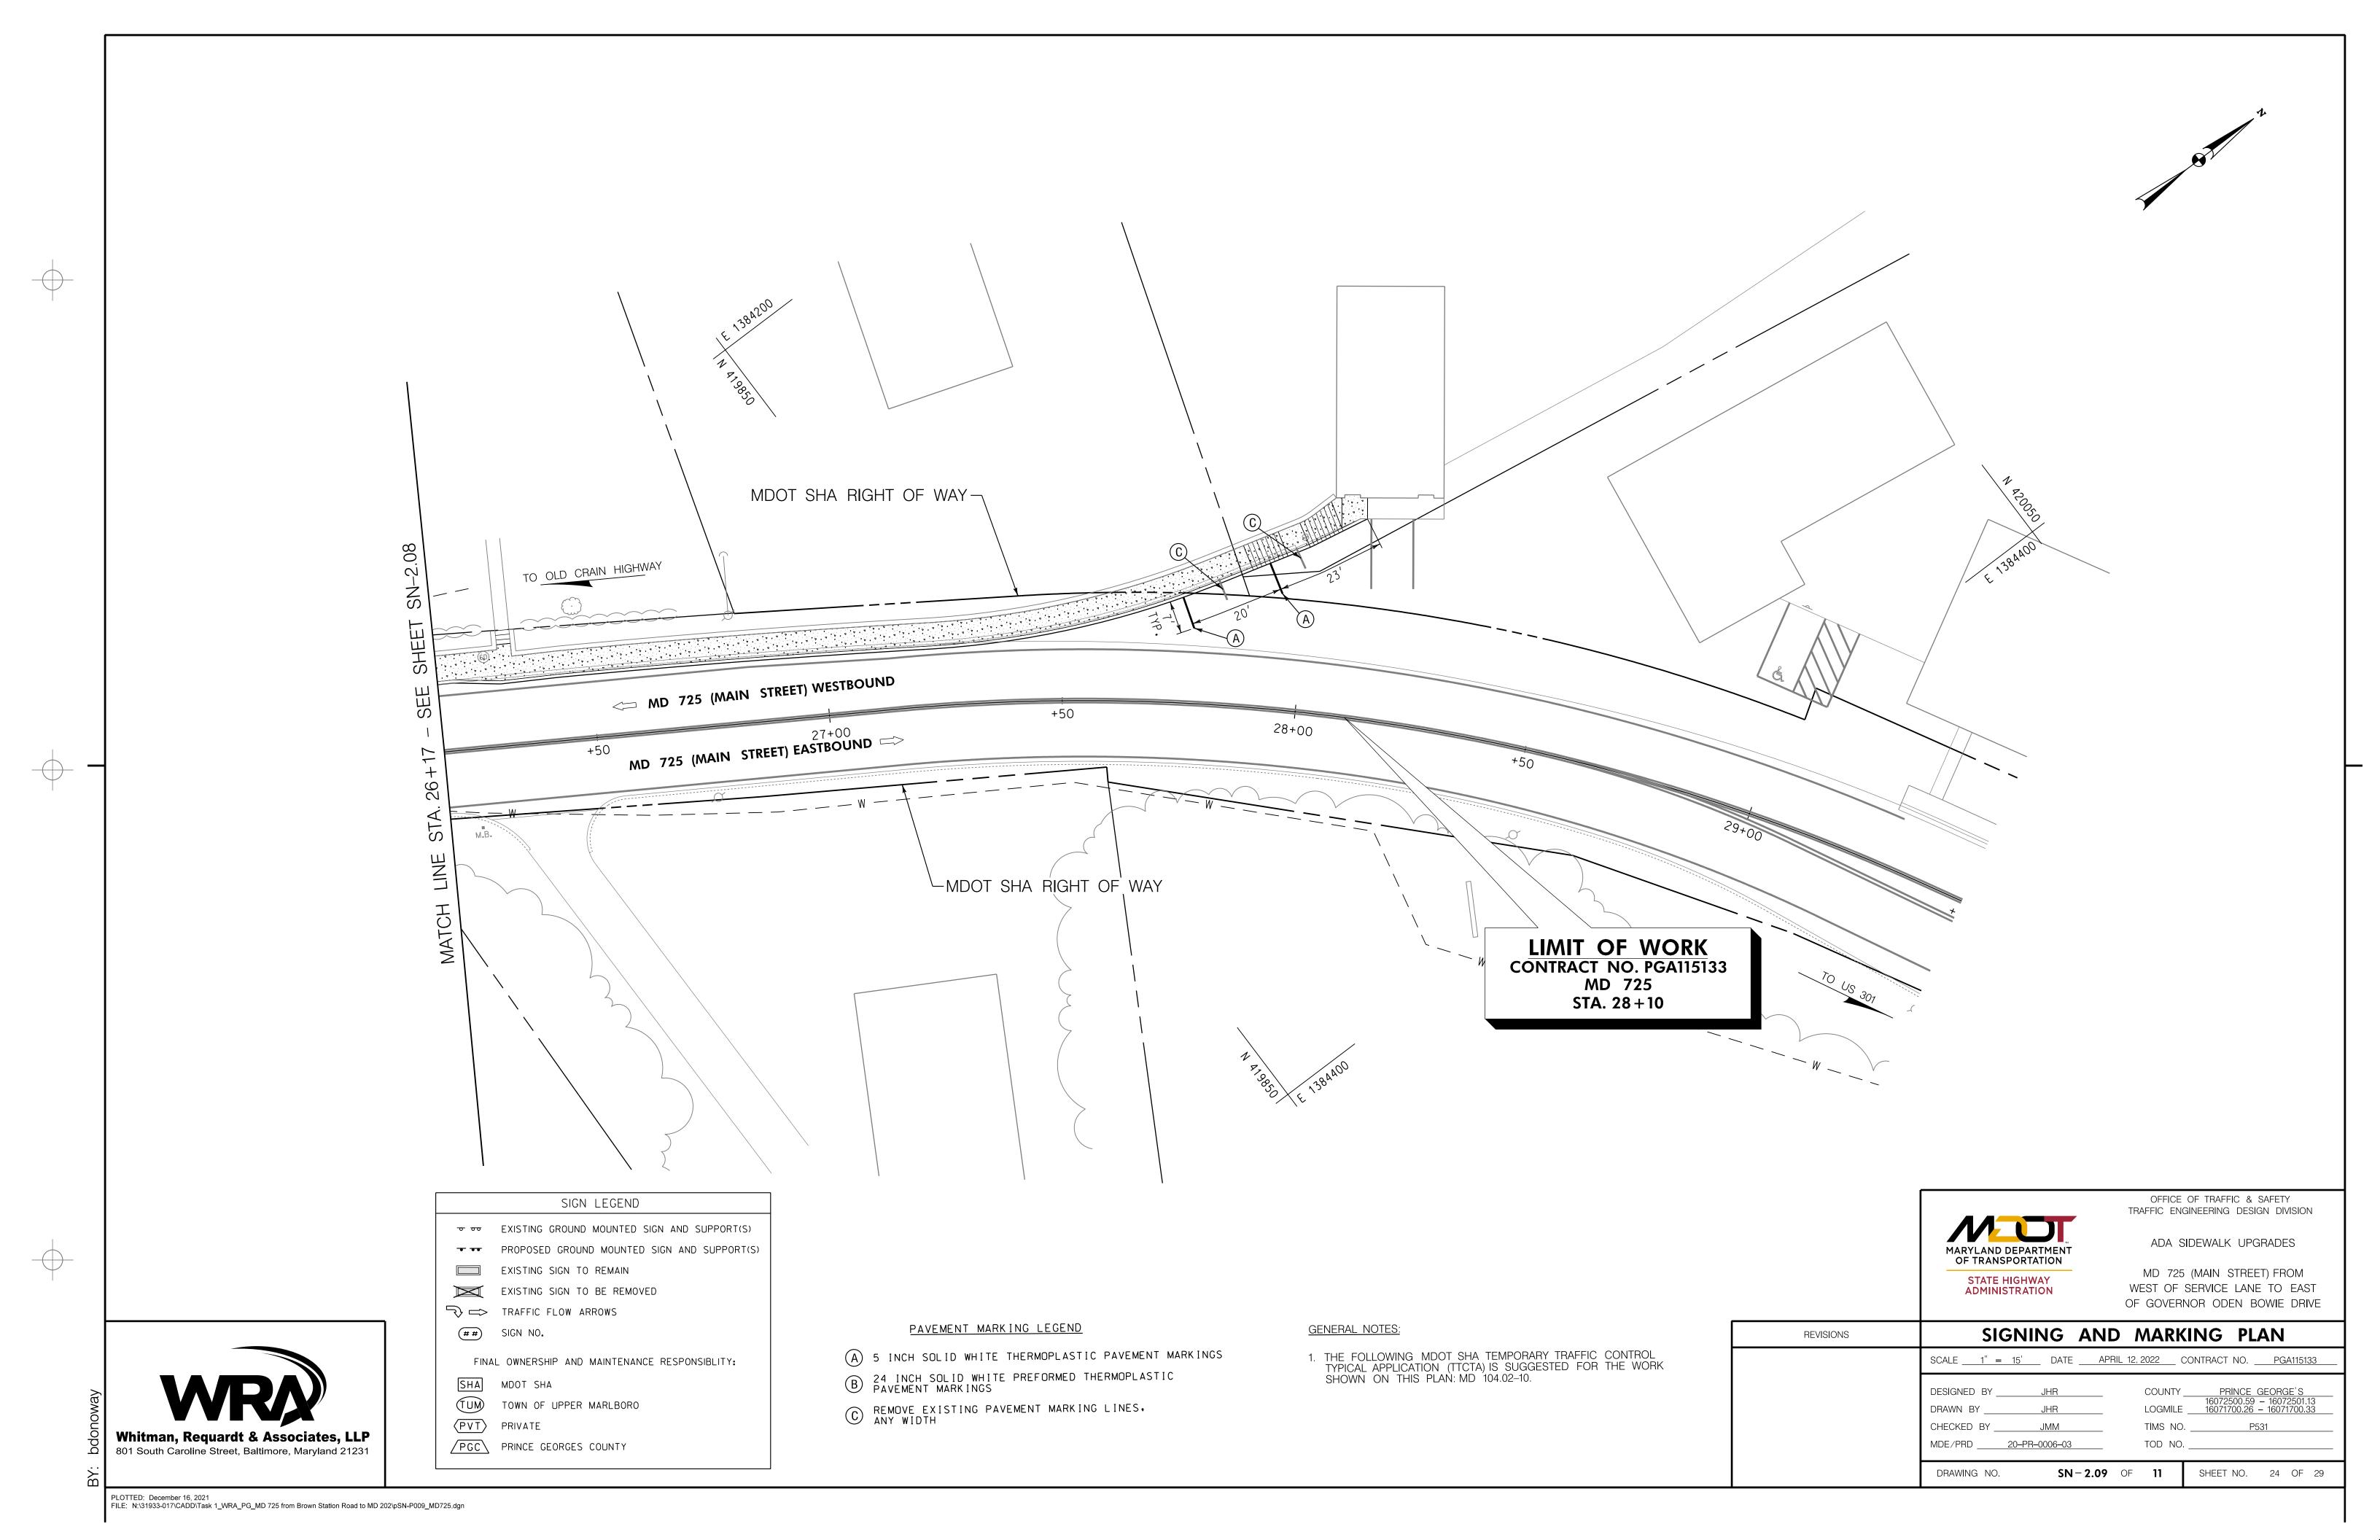

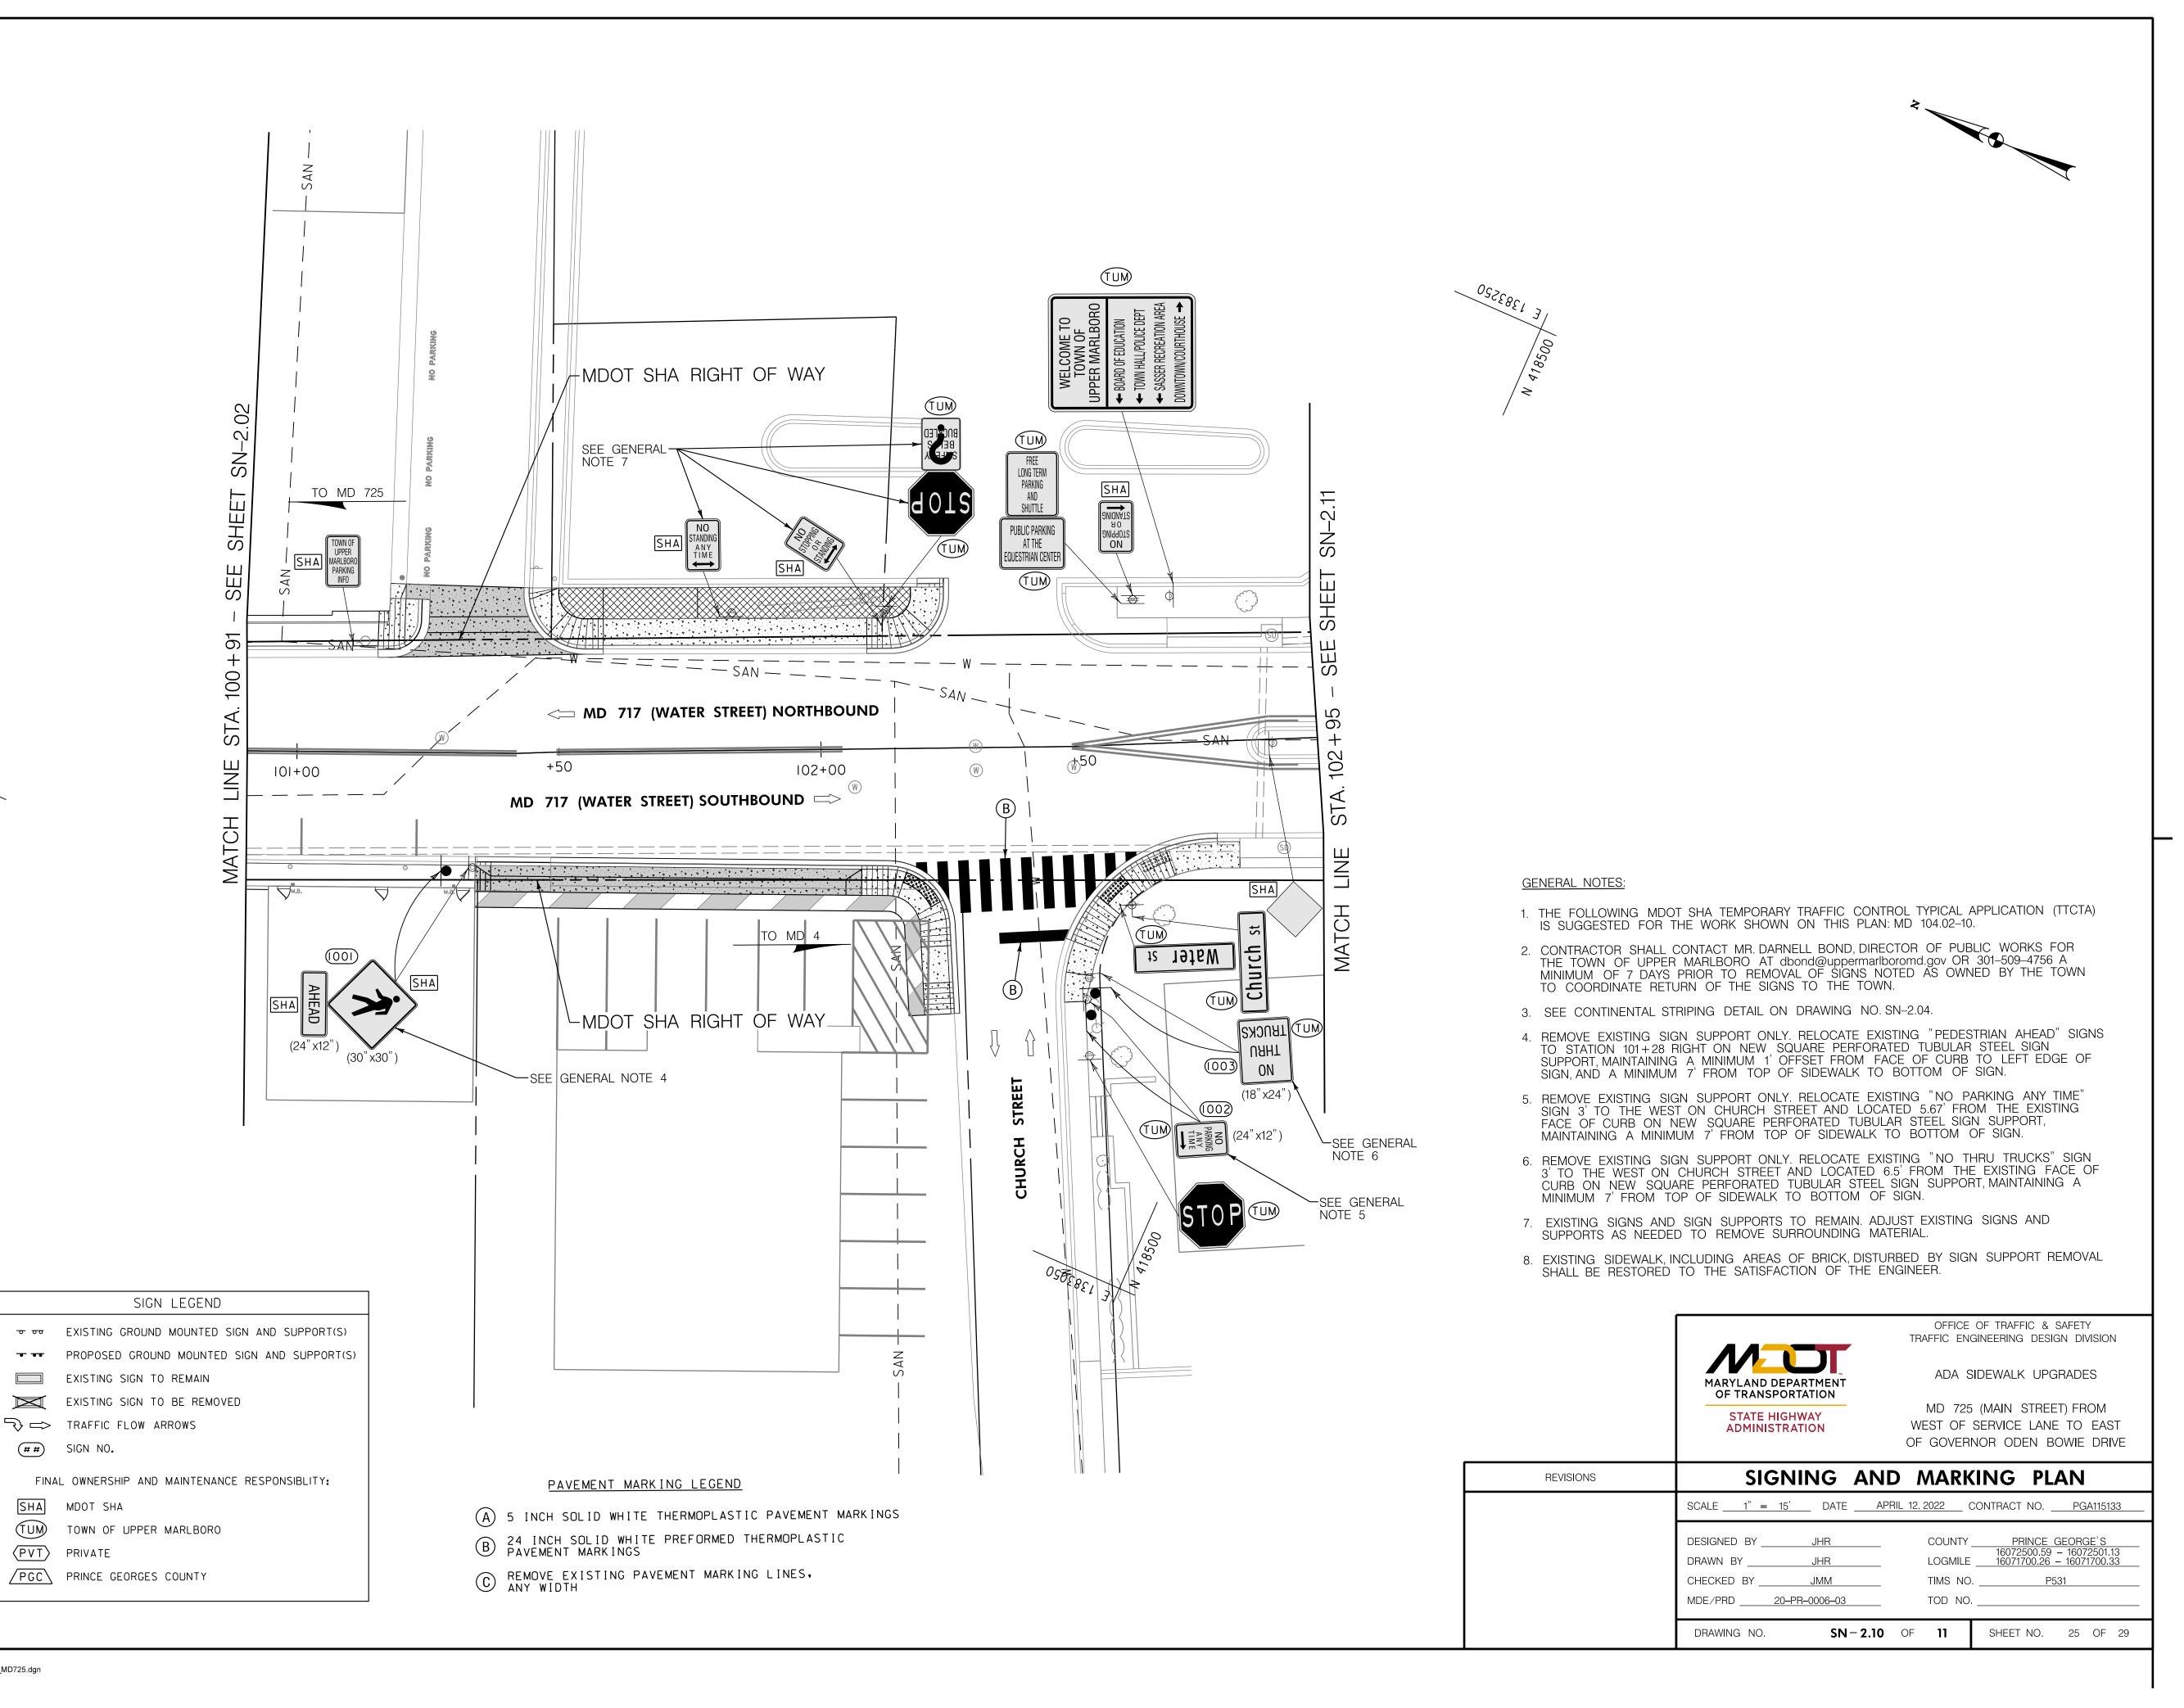

Whitman, Requardt & Associates, LLP 801 South Caroline Street, Baltimore, Maryland 21231

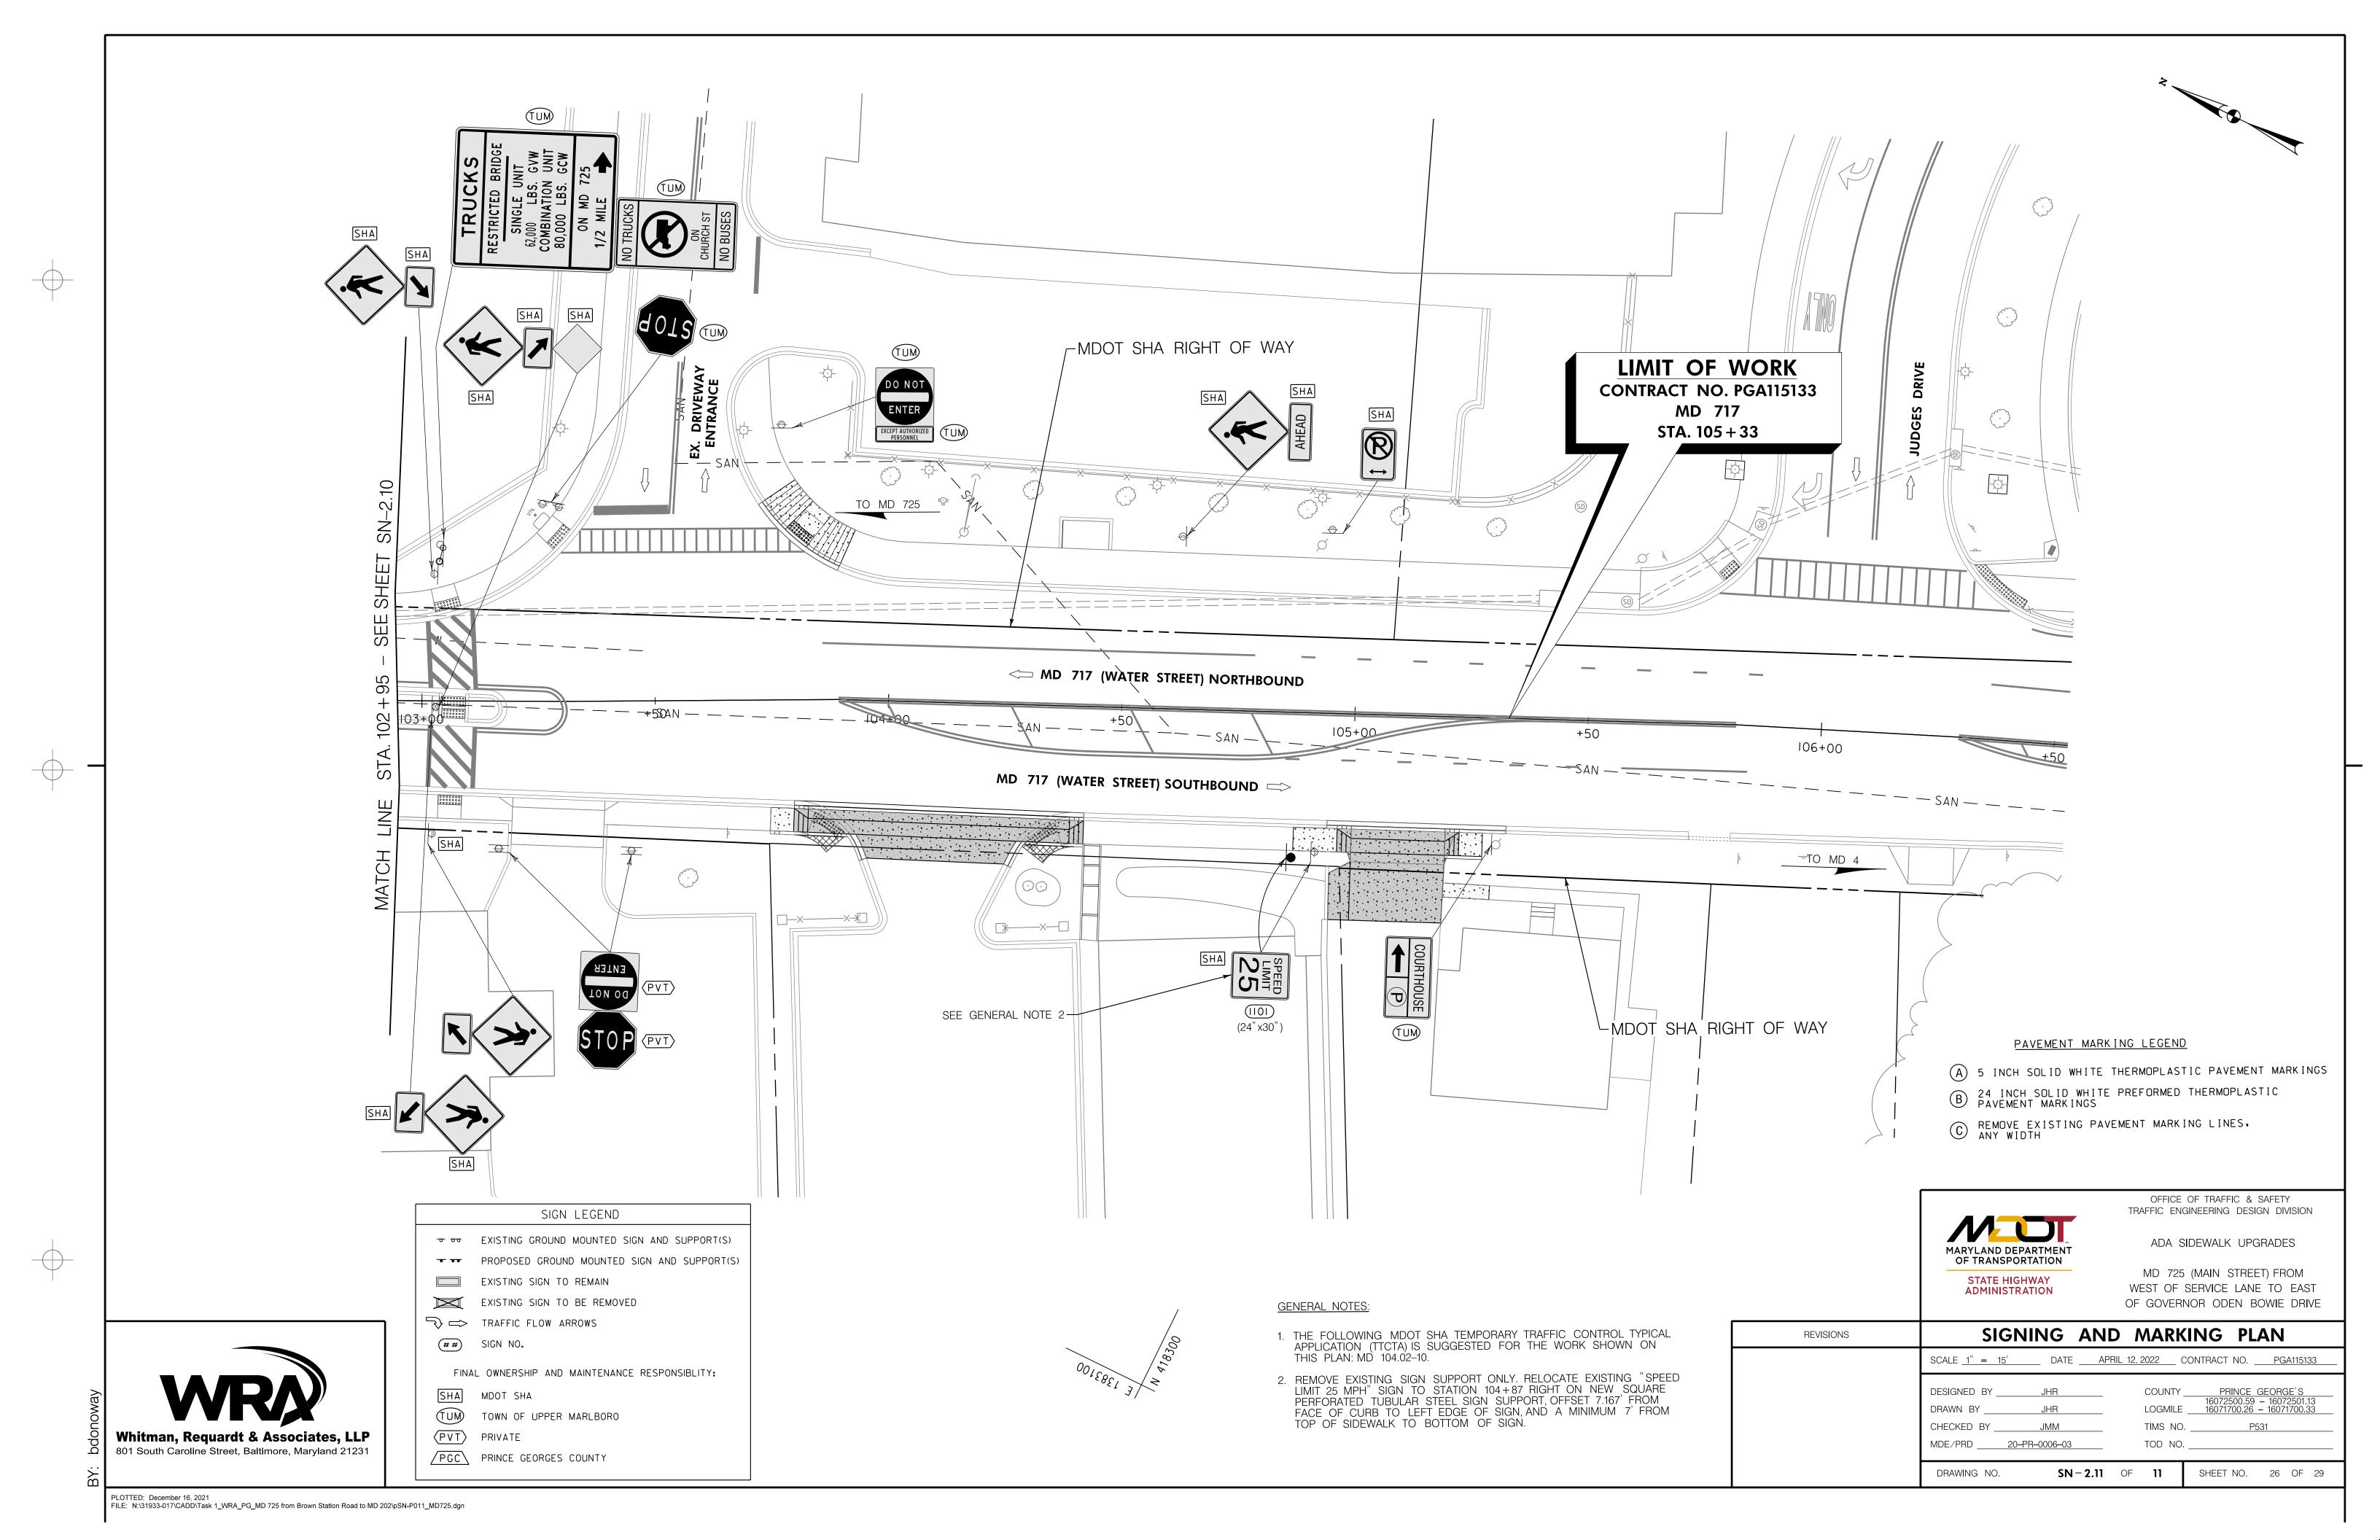

SHEET	SIGN	DEMARKS							COI	DE NUMBER	?S *						
SHEET NO.	SIGN NO.	REMARKS	I	2	3	4	5	6	7	8	9	10	11	12	13	14	15
SN-2.0I		CODE NO. 4					17.875										
SN-2.02		CODE NO. 4					33.75										
SN-2.03	301	RELOCATE EX. "NO U-TURN" SIGN (24" × 24") SQL	UARE PERFORATED TUBULAR STEEL SIGN POST & ANCHOR BASE	I	ı	4											
	302	RELOCATE EX. "PEDESTRIAN" & "AHEAD" SIGNS (30" x 30") & (24" x 12")	UARE PERFORATED TUBULAR STEEL SIGN POST & ANCHOR BASE	1	I	8.25											
	303	RELOCATE EX. "NO PARKING POLICE PARKING ONLY" & "VIOLATORS WILL BE TOWED" SIGNS (12" x 18") & (12" x 6") SQL CODE NO. 4	UARE PERFORATED TUBULAR STEEL SIGN POST & ANCHOR BASE	I	I	2	10										
SN-2.04	401	RI-6a(3)(L) (30" × 30")	UARE PERFORATED TUBULAR STEEL SIGN POST & ANCHOR BASE 6.25		l												
	402		UARE PERFORATED TUBULAR STEEL SIGN POST & ANCHOR BASE 6.25	ı													
		CODE NO. 4					35.875										
SN-2.06	601	RELOCATE EX. "SPEED LIMIT 25 MPH" SIGN (24" × 30")	UARE PERFORATED TUBULAR STEEL SIGN POST & ANCHOR BASE	I	ı	5											
	602	RELOCATE EX. "NO PARKING" SIGN (12" × 18")	UARE PERFORATED TUBULAR STEEL SIGN POST & ANCHOR BASE	I	ı	1.5											
SN-2.07	701	RELOCATE EX. "NO PARKING" SIGN (12" × 18") SQL	UARE PERFORATED TUBULAR STEEL SIGN POST & ANCHOR BASE	I	I	I . 5											
CN 210	1001	DELOCATE EX UDEDECTRIANU A HALIEADU CIONE (ZOU ZOU) A (OAU LOU)	HADE DEDEODATED THRU AD CTEEL CICAL DOCT A ANGUIOD DACE	ļ.,		0.05											
SN-2.10	1001		UARE PERFORATED TUBULAR STEEL SIGN POST & ANCHOR BASE UARE PERFORATED TUBULAR STEEL SIGN POST & ANCHOR BASE			8.25											
	1002		UARE PERFORATED TUBULAR STEEL SIGN POST & ANCHOR BASE	'	<u> </u> '	3											
	1003	NEEDOWNE EXAMINE THROWS SIGHT HE X ETY	SAME FERRISHMED TOBOLAN STEEL SIGN FOOT & AMOUNT BASE	· ·	·	3											
SN-2.II	1101	RELOCATE EX. "SPEED LIMIT 25 MPH" SIGN (24" x 30")	UARE PERFORATED TUBULAR STEEL SIGN POST & ANCHOR BASE	I	I	5											
PAVEMEN	T MARKIN	GS .															
SN-2.04									85	115							
SN-2.09 SN-2.10								15	100	10							
311-2.10									100								
TOTAL QL			12.5	12	12	40	97.5	15	185	125							
PROPOSE	O QUANTI	TIES	15	13	13	45	105	20	205	140							



	* CODE	NUMBER DE	SCRIPTION & UNIT		
CODE NUMBERS	DESCRIPTION	UNIT	CODE NUMBERS	DESCRIPTION	UNIT
I	SHEET ALUMINUM SIGNS	SF	9		
2	SQUARE PERFORATED TUBULAR STEEL SIGN POSTS	EA	10		
3	SQUARE TUBULAR STEEL ANCHOR BASES	EA	П		
4	RELOCATE EXISTING GROUND MOUNTED SIGNS	SF	12		
5	REMOVE EXISTING GROUND MOUNTED SIGNS & SUPPORTS	SF	13		
6	5" WHITE THERMOPLASTIC PAVEMENT MARKINGS	LF	14		
7	24" WHITE PREFORMED THERMOPLASTIC PAVEMENT MARKING LINES	LF	15		
8	REMOVAL OF EXISTING PAVEMENT MARKING LINES, ANY WIDTH	LF			

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	 IGHW TRAT		


OFFICE OF TRAFFIC & SAFETY
TRAFFIC ENGINEERING DESIGN DIVISION

ADA SIDEWALK UPGRADES

DEPARTMENT PORTATION

MD 725 (MAIN STREET) FROM WEST OF SERVICE LANE TO EAST OF GOVERNOR ODEN BOWIE DRIVE

REVISIONS	INDEX OF QUANTITIES
	SCALE N.T.S. DATE APRIL 12, 2022 CONTRACT NO. PGA115133
	DESIGNED BY JHR COUNTY PRINCE GEORGE'S 16072500.59 - 16072501.13 16072500.59 - 16072501.13 DRAWN BY JHR LOGMILE 16071700.26 - 16071700.33 CHECKED BY JMM TIMS NO. P531 MDE/PRD 20-PR-0006-03 TOD NO.
	DRAWING NO. SN-11.01 OF 1 SHEET NO. 27 OF 29

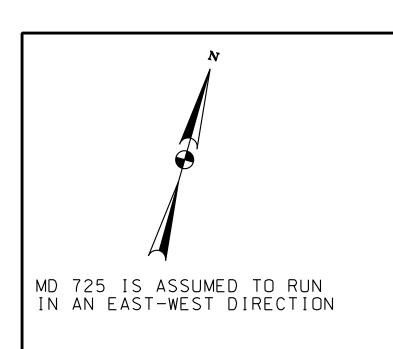


CONSTRUCTION DETAILS


- A. INSTALL CONCRETE FOUNDATION WITH 14 FT. STEEL PEDESTAL POLE WITH BREAKAWAY TRANSFORMER BASE, POLE MOUNTED CONTROLLER CABINET, SOLAR POWER EQUIPMENT, RECTANGULAR RAPID-FLASHING BEACON, SIGNS, AND PEDESTRIAN PUSHBUTTON AND R10-4MOD/R10-25 SIGNS. (SEE INSTALLATION DETAIL ON DWG. NO. SG-02) (INSTALL 1-3 IN. SCHEDULE 80, 90 DEGREE
- PVC ELECTRICAL CONDUIT BENDS IN PEDESTAL BASE). B. INSTALL CONCRETE FOUNDATION WITH 14 FT. STEEL PEDESTAL POLE WITH BREAKAWAY TRANSFORMER BASE, POLE MOUNTED CONTROLLER CABINET, CELLULAR ANTENNA AND LEAD-IN CABLE, SOLAR POWER EQUIPMENT, RECTANGULAR RAPID-FLASHING BEACON, SIGNS, AND PEDESTRIAN PUSHBUTTON AND R10-4 MOD/R10-25 SIGNS. (SEE INSTALLATION DETAIL ON DWG. NO. SG-02) (INSTALL 1-3 IN. SCHEDULE 80, 90 DEGREE PVC ELECTRICAL CONDUIT BENDS IN PEDESTAL BASE).
- C. INSTALL HANDHOLE WITH GROUND ROD. D. INSTALL 3 INCH CONDUIT- TRENCHED. INSTALL NO. 6 AWG STRANDED BARE COPPER GROUND WIRE FROM EMBEDDED GROUND ROD TO PEDESTAL POLE GROUND
- E. INSTALL 24 IN. WHITE THERMOPLASTIC PAVEMENT MARKING FOR CROSSWALKS. F. INSTALL 24 IN. WHITE THERMOPLASTIC PAVEMENT MARKING FOR STOP LINE.

G. REMOVE EXISTING PAVEMENT MARKING LINES, ANY WIDTH.


PROPOSED RECTANGULAR RAPID-FLASHING (RRFB) BEACON SIGNS

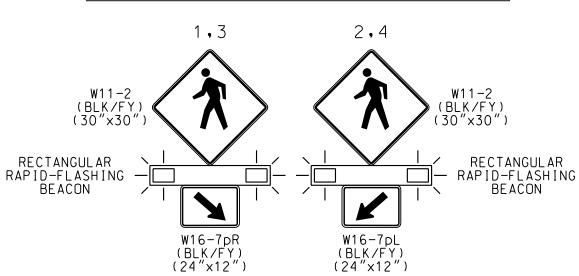

PROPOSED PUSHBUTTON SIGNS

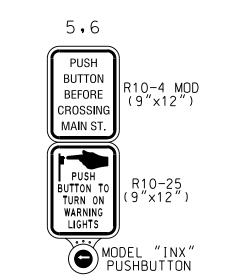



PROPOSED CELLULAR ANTENNA

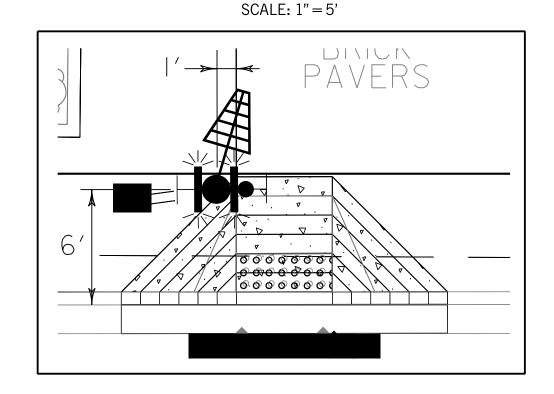



DIMENSION DETAIL 'A'



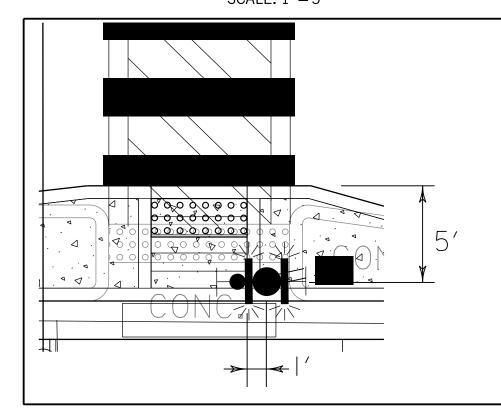

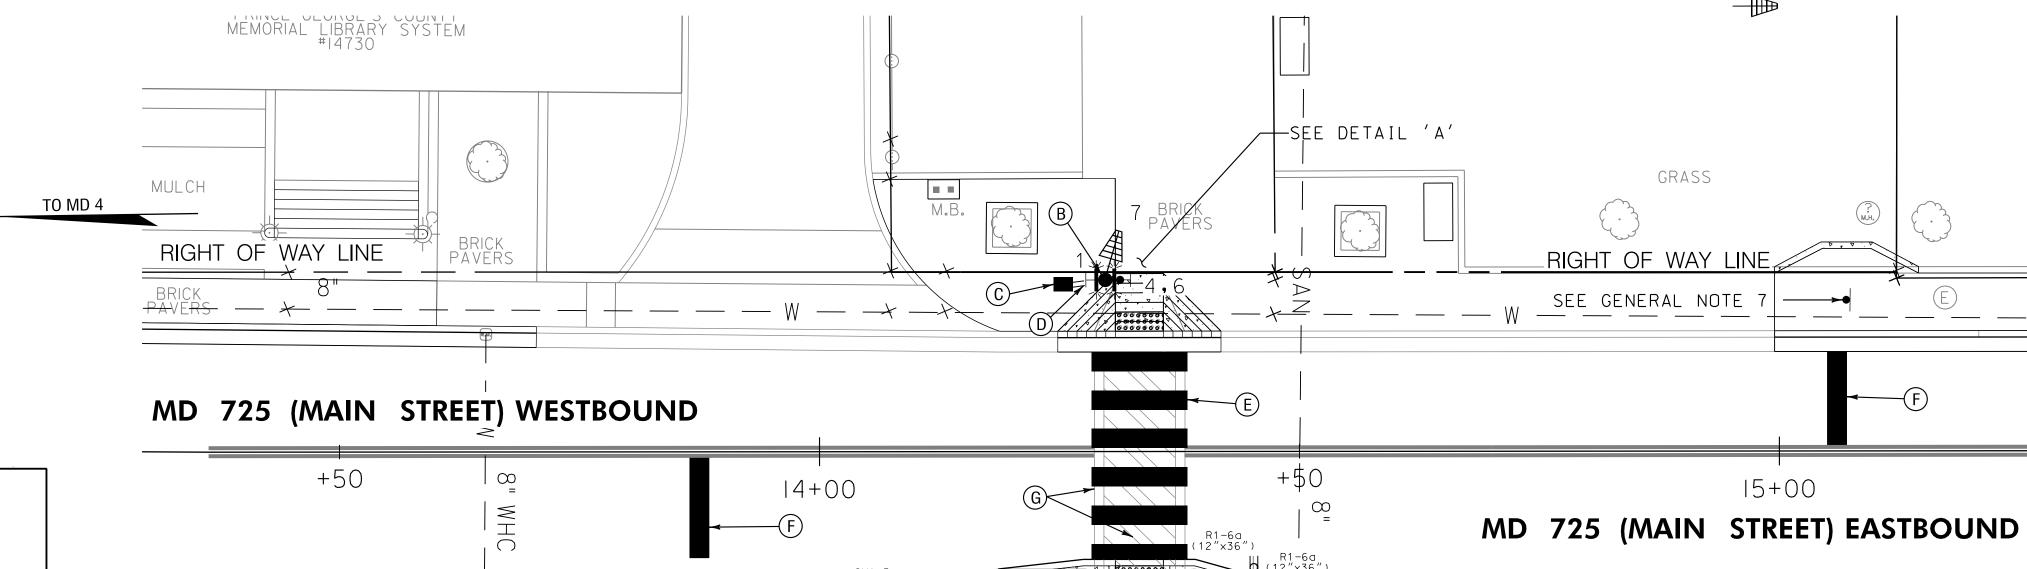

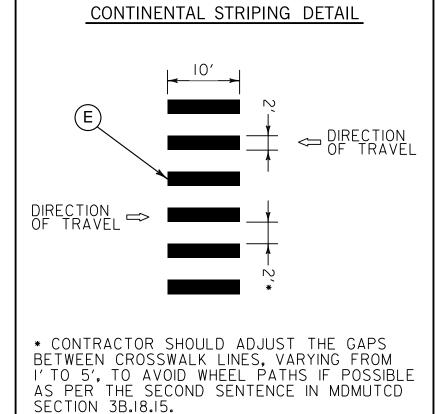

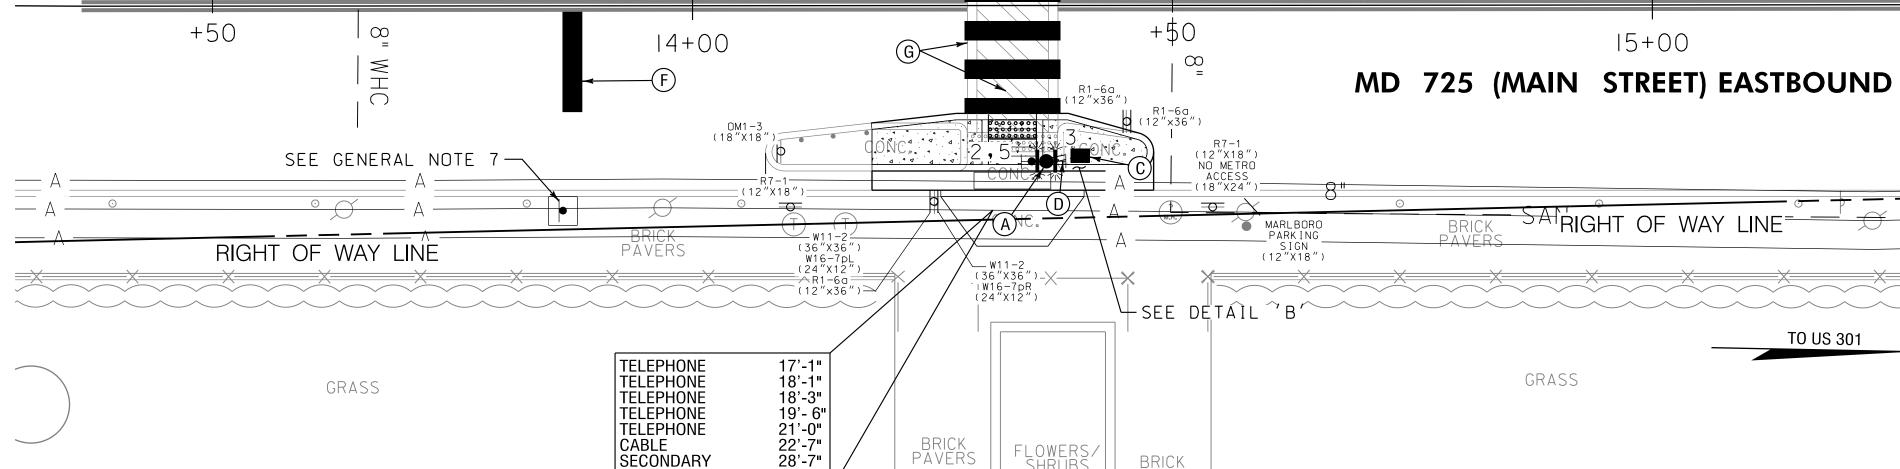

PAVERS

FLOWERS/ SHRUBS

BRICK PAVERS

GENERAL NOTES

- 1. ALL TRAFFIC SIGNAL FOUNDATIONS SHALL BE INSTALLED AT THE FINAL SIDEWALK OR CURB GRADE FOR CLOSED SECTIONS, HIGHEST ROADWAY PROFILE GRADE FOR OPEN SECTIONS, TO MEET CLEARANCES AS SPECIFIED IN MD 816.03, MD 818.01, MD 818.02, MD 818.04. THE CONTRACTOR SHALL VERIFY ULTIMATE GRADES PRIOR TO THE INSTALLATION OF ALL SIGNAL EQUIPMENT.
- 2. THE CONTRACTOR SHALL VERIFY ALL UNDERGROUND UTILITIES PRIOR TO INSTALLING PROPOSED SIGNAL EQUIPMENT. IF ANY UTILITY CONFLICTS SHOULD ARISE THE CONTRACTOR SHALL CONTACT THE PROJECT ENGINEER.

 $N\Lambda$

CABLE

SECONDARY

TWISTED PRIMARY 29'-5"

- 3. VERIFY PROPOSED GEOMETRICS PRIOR TO INSTALLING SIGNAL EQUIPMENT.
- 4. REFER TO ROADWAY PLANS FOR SIDEWALK RAMPS DETAILS.
- 5. PUSHBUTTONS ARE TO BE LOCATED SO THAT THEY CAN BE ACTIVATED BY A PERSON IN A WHEELCHAIR REACHING LESS THAN 18" FROM A 60" imes 60" LEVEL LANDING AREA WITH A CROSS SLOPE OF LESS THAN OR EQUAL TO 2%.
- 6. LOCATION OF ACCESSIBLE PEDESTRIAN SIGNAL PUSHBUTTONS MUST MEET LOCATION REQUIREMENTS OF MUTCD SEC. 4E.08 AND 4E.10 AND FIG. 4E-3 AND 4E-4 OF THE NCHRP PUBLICATION, "ACCESSIBLE PEDESTRIAN SIGNALS: GUIDE TO BEST PRACTICE". IF NOT MET, THE CONTRACTOR IS TO STOP WORK ON PUSHBUTTON LOCATIONS UNTIL A DESIGN WAIVER IS OBTAINED, APPROVED BY THE DIRECTOR, OFFICE OF TRAFFIC AND SAFETY.
- 7. REFER TO SIGNING AND MARKING PLANS FOR SIGN INSTALLATION DETAILS.

SPECIAL NOTE:

CONTRACTOR SHALL USE CAUTION WHEN INSTALLING 14 FT. PEDESTAL POLE TO AVOID DISTURBANCE OF EXISTING UNDERGROUND UTILITIES. CONTRACTOR SHALL TEST PIT TO DETERMINE EXACT LOCATION AND DEPTH OF UNDERGROUND UTILITIES PRIOR TO INSTALLING SIGNAL EQUIPMENT. CONTRACTOR SHALL EXCAVATE FOUNDATION BY HAND IN ORDER TO MINIMIZE POSSIBLE DAMAGE TO EXISTING UNDERGROUND UTILITIES.



OFFICE OF TRAFFIC & SAFETY TRAFFIC ENGINEERING DESIGN DIVISION

RECTANGULAR RAPID-FLASHING BEACON MD 725 (MAIN STREET) AT PRINCE GEORGES COUNTY CIRCUIT COURTHOUSE UPPER MARLBORO, MD

GEOMETRIC LEGEND	APPROVALS	REVISIONS	TRAFFIC SIGNALIZATION PLAN						
EXISTING PROPOSED	Robert Stewart 01/11/22		SCALE <u>1" = 10'</u> DATE <u>APRIL 12, 2022</u> CONTRACT NO. <u>PGA115133</u>						
<u>UTILITY LEGEND</u> ——SD——SD—— STORM DRAIN	TEAM LEADER		DESIGNED BY B. DONOWAY COUNTY PRINCE GEORGES						
G GAS MAIN W W WATER MAIN	Adison Zoretic 1/12/2022 ASST. DIV. CHIEF		DRAWN BYB. DONOWAY LOGMILE16072500.86						
SSEWER MAINE	Dialin Tian 2/1/2022		CHECKED BY J. MOCNY TIMS NO P531 MDE/PRD SEE TITLE SHEET TOD NO.						
—— A —— A —— AERIAL CABLES —— T —— T —— TELEPHONE CABLES			MDE/TITID OLE TITLE SHILLT TOD NO.						
F F F F F IBER-OPTIC	Cedric Ward 2/2/22		TS NO. 5235 DRAWING SG- 01 OF 2 SHEET NO. 28 OF 29						



PROJECT DESCRIPTION EQUIPMENT LIST "A" EQUIPMENT LIST "B" GENERAL A. EQUIPMENT TO BE SUPPLIED BY THE MDOT SHA B. EQUIPMENT TO BE FURNISHED AND/OR INSTALLED BY THE CONTRACTOR THIS PORTION OF THE PROJECT INVOLVES THE INSTALLATION OF PEDESTRIAN RECTANGULAR RAPID-FLASHING DESCRIPTION ITEM NO. QUANTITY ITEM NO. QUANTITY DESCRIPTION BEACONS (RRFB) AT THE PEDESTRIAN CROSSING ON MD 725 (MAIN STREET) AND THE COURTHOUSE MID-BLOCK CORSSING LOCATED BETWEEN W. AND E. COURT DRIVES IN PRINCE GEORGE'S COUNTY, MARYLAND, MD 725 IS ASSUMED TO RUN IN AN EAST-WEST DIRECTION. 973025 SHEET ALUMINUM MAST ARM/POLE MOUNTED SIGN: 36 S.F. 203030 2 C.Y. TEST PIT EXCAVATION - 2 EACH R10-4 MOD (9 IN. \times 12 IN.) - POLE MOUNT INTERSECTION OPERATION 549800 115 L.F. REMOVAL OF EXISTING PAVEMENT MARKING LINES, ANY WIDTH APS MESSAGE FOR CROSSING MD 725 (MAIN STREET): R10-25 (9 IN. \times 12 IN.) - POLE MOUNT 549419 82 L.F. 24 INCH WHITE THERMOPLASTIC PAVEMENT MARKINGS A. WHEN A PEDESTRIAN LOCATES AND PRESSES PUSHBUTTON FOR AN EXTENDED TIME, THE PUSHBUTTON UNIT WILL ANNOUNCE "YELLOW LIGHTS ARE FLASHING FOR CROSSING MAIN STREET. WATCH FOR TRAFFIC. USE W11-2 (BLK/FY) (30 IN. \times 30 IN.) - POLE MOUNT - 4 EACH 800000 1 L.S. RECTANGULAR RAPID-FLASHING BEACONS ASSEMBLY CAUTION." AUDIBLE MESSAGE SHALL BE SPOKEN TWICE PER ACTIVATION. W16-7pL (BLK/FY) (24 IN. \times 12 IN.) - POLE MOUNT 800000 20 L.F. ELECTRICAL CABLE - 8 CONDUCTOR (NO. 18 AWG) FOR MODEL INX APS PUSHBUTTON - 2 EACH W16-7pR (BLK/FY) (24 IN. \times 12 IN.) - POLE MOUNT VIBROTACTILE OR PERCUSSIVE INDICATIONS SHALL NOT BE USED IN CONJUNCTION WITH AUDIBLE PUSHBUTTON INFORMATION MESSAGE. 800000 2 EACH AUDIBLE/TACTILE PEDESTRIAN MODEL INX PUSHBUTTON STATION WITH LED AND SIGN 974100 CELLULAR MODEM, ANTENNA AND LEAD-IN CABLE 1 EACH CONTROLLER REQUIREMENTS 801004 1.4 C.Y CONCRETE FOR SIGNAL FOUNDATION RAPID RECTANGULAR FLASHING BEACON (POLE MOUNTED CONTROLLER CABINET AND SOLAR PANEL) ASSEMBLY, WITH 802501 30 L.F. NO. 6 AWG STRANDED BARE COPPER GROUND WIRE COMMUNICATIONS. 805135 20 L.F. 3 INCH SCHEDULE 80 RIGID PVC CONDUIT - TRENCHED 811001 2 EA FURNISH AND INSTALL ELECTRICAL HANDHOLE MAINTENANCE OF TRAFFIC EQUIPMENT LIST "C" 813015 36 S.F. INSTALL OVERHEAD SIGN THE FOLLOWING TRAFFIC CONTROL STANDARDS SHALL BE REFERENCED FOR THE PROJECT. 815425 1 EACH INSTALL CELLULAR ANTENNA AND LEAD-IN CABLE ADDITIONAL TRAFFIC CONTROL STANDARDS MAY BE USED AS DIRECTED BY THE ENGINEER. NO EQUIPMENT TO BE REMOVED AND RETURNED TO MDOT SHA 14 FOOT BREAKAWAY PEDESTAL POLE 818010 2 EACH STANDARD NO. MD-104.02-02 (SHOULDER WORK) 837001 2 EACH GROUND ROD - 3/4 INCH DIAMETER X 10 FOOT LENGTH STANDARD NO. MD-104.02-10 (FLAGGING OPERATION) STANDARD NO. MD-104.06-10 (MOBILE SERVICE WORK/INTERSECTION) PROJECT CONTACTS THE CONTACT PERSONS FOR MDOT SHA ARE AS FOLLOWS: PHASE CHART DISTRICT 3 - PRINCE GEORGES CO. OFFICE OF TRAFFIC AND SAFETY MS. ERICA RIGBY VIVIAN BERRA-FIGUEREO, P.E. DEPUTY DIRECTOR, OFFICE OF TRAFFIC AND SAFETY 1 2 3 DISTRICT ENGINEER PHONE: (301) 513-7346 PHONE: (410) 787-7630 REBECCA LICHTENSTEIN, P.E. ASSISTANT DIVISION CHIEF MR. DEREK GUNN DEPUTY DISTRICT ENGINEER PHONE: (301) 513-7498 TRAFFIC OPERATIONS DIVISION REST DARK DARK DARK DARK PHONE: (410) 787-7625 MR. JOHN GOVER (FIELD) PHONE: (301) 513-7336 MR. MICHAEL BASSO ASSISTANT DISTRICT ENGINEER CONSTRUCTION CHIEF, SIGNAL OPERATIONS PED ACTIVATED RFL RFL RFL RFL PHONE: (410)-787-7652 RAPID FLASHING MS. AMY ANDREWS (ADMIN.) ASSISTANT DISTRICT ENGINEER CONSTRUCTION MR. DAVID (TODD) JONES RFL = RAPID FLASH (SEE RRFB FLASHING NOTES) MANAGER, SHA SIGN OPERATIONS PHONE: (410) 787-7676 PHONE: (301) 513-7300 MR. JUSTIN SOSEBEE ASSISTANT DISTRICT ENGINEER -MR. MICHAEL BOYLE MAINTENANCE (PRINCE GEORGES) OOTS, SIGNAL WAREHOUSE PHONE: (301) 776-7619 PHONE: (410) 787-7673 MR. MARK LOEFFLER DISTRICT UTILITY ENGINEER PHONE: (301) 513-7350 ASSISTANT DISTRICT ENGINEER - TRAFFIC (PRINCE GEORGES) PHONE: (301) 513-7409 EXAMPLE RRFB INSTALLATION DETAILS RRFB UNIT DETAIL WIRING DIAGRAM (SEE DWG. NO. SG-01 FOR SIGNS/RRFB/PUSHBUTTON PLACEMENT) RRFB FLASHING NOTES LEFT INDICATION--RIGHT INDICATION

ALL FLASHING UNITS AT THE CROSSING SHALL OPERATE IN UNISON UPON ACTIVATION.

FLASHING OPERATION SHALL CONFORM TO THE REQUIREMENTS OF FHWA IA-21.


RRFB SHALL PROVIDE 75 FLASHING SEQUENCES PER MINUTE USING THE FOLLOWING 800-MILLISECOND FLASHING SEQUENCE, THE LEFT AND RIGHT RRFB INDICATIONS SHALL OPERATE USING THE FOLLOWING SEQUENCE:

1. THE RRFB INDICATION ON THE LEFT-HAND SIDE SHALL BE ILLUMINATED FOR APPROXIMATELY 50 MILLISECONDS.


- 2. BOTH RRFB INDICATIONS SHALL BE DARK FOR APPROXIMATELY 50 MILLISECONDS.
- 3. THE RRFB INDICATION ON THE RIGHT-HAND SIDE SHALL BE ILLUMINATED FOR APPROXIMATELY 50 MILLISECONDS.
- 4. BOTH RRFB INDICATIONS SHALL BE DARK FOR APPROXIMATELY 50 MILLISECONDS.
- 5. THE RRFB INDICATION ON THE LEFT-HAND SIDE SHALL BE ILLUMINATED FOR APPROXIMATELY 50 MILLISECONDS.
- 6. BOTH RRFB INDICATIONS SHALL BE DARK FOR APPROXIMATELY 50 MILLISECONDS.
- 7. THE RRFB INDICATION ON THE RIGHT-HAND SIDE SHALL BE ILLUMINATED FOR APPROXIMATELY 50 MILLISECONDS.
- 8. BOTH RRFB INDICATIONS SHALL BE DARK FOR APPROXIMATELY 50 MILLISECONDS.
- 9. BOTH RRFB INDICATIONS SHALL BE ILLUMINATED FOR APPROXIMATELY 50 MILLISECONDS.
- 10. BOTH RRFB INDICATIONS SHALL BE DARK FOR APPROXIMATELY 50 MILLISECONDS.
- 11. BOTH RRFB INDICATIONS SHALL BE ILLUMINATED FOR APPROXIMATELY 50 MILLISECONDS.
- 12. BOTH RRFB INDICATIONS SHALL BE DARK FOR APPROXIMATELY 250 MILLISECONDS



CREAR VIEW EQUIPMENT NOT SHOWN FOR CLARITY)

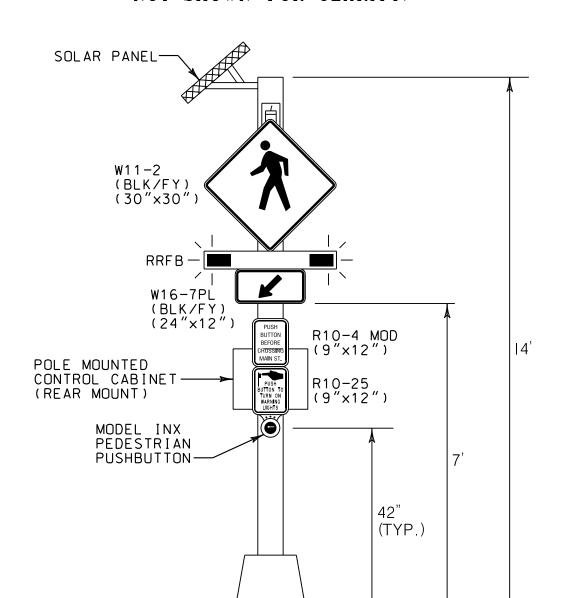

EXAMPLE REAR VIEW
(FRONT VIEW EQUIPMENT NOT SHOWN FOR CLARITY)

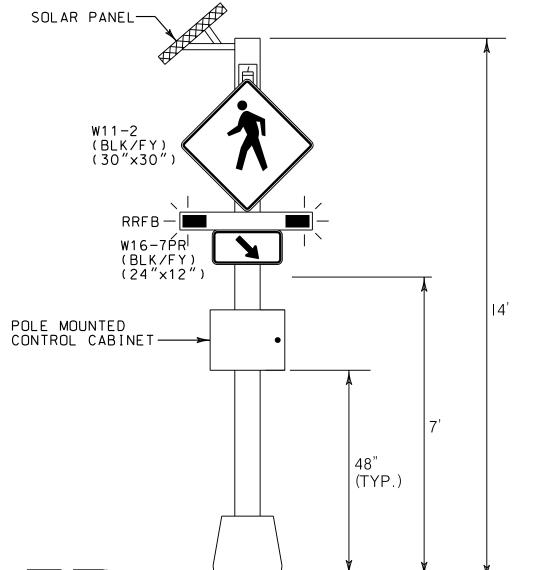


NOTE:

TOTAL WIDTH OF HOUSING SHALL NOT PROJECT BEYOND THE OUTSIDE EDGES OF THE W11-2 SIGN AND SUPPLEMENTS.

NDICATION



WIRING KEY:

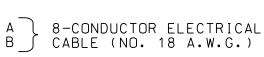

(NO. 6 A.W.G.) BARE COPPER GROUND WIRE

→ PROPOSED 3/4 IN. X 10 FT. GROUND ROD



OFFICE OF TRAFFIC & SAFETY
TRAFFIC ENGINEERING DESIGN DIVISION

RECTANGULAR RAPID-FLASHING BEACON MD 725 (MAIN STREET) AT PRINCE GEORGES COUNTY CIRCUIT COURTHOUSE UPPER MARLBORO, MD

REVISIONS	GENERAL INFORMATION SHEET
	SCALE N.T.S. DATE APRIL 12, 2022 CONTRACT NO. PGA115133
	DESIGNED BY B. DONOWAY COUNTY PRINCE GEORGES DRAWN BY B. DONOWAY LOGMILE 16072500.86 CHECKED BY J. MOCNY TIMS NO. P531 MDE/PRD SEE TITLE SHEET TOD NO.
	TS NO. 5235 DRAWING SG- 02 OF 2 SHEET NO. 29 OF 29